

- ### DEMOLITION PLAN KEYED NOTES

- 1 G.C. TO REMOVE 10 SEATS (EACH SIDE), SALVAGE, AND DELIVER TO OWNER.
- 2 REMOVE FLOOR FINISHES AS REQUIRED WITHIN LIMITS SHOWN DOWN TO CONCRETE BELOW AND PREPARE FOR NEW CONCRETE PLACEMENT OVER (E) CONCRETE TIERS TO REMAIN. CARPET CUT LINE TO OCCUR NO GREATER THAN 2" FROM NEW CONCRETE PLACEMENT LIMITS TO ALLOW FOR BATTEN TRIM COVERING OF DEMOLISHED FINISHES TO NEW CARPET AT WALLS ABOVE. SEE DETAIL A/S-1.1 FOR MORE INFORMATION.
- 3 DEMOLISH WALLS AS REQUIRED FOR NEW DOOR OPENINGS. (C). TO VERIFY FRAMING ABOVE (BEAM OR BEARING WALL) AND PROVIDE SHORING AS NECESSARY TO INSTALL NEW DOOR FRAME REQUIRED. CUT FINISHES TIGHT TO NEW DOOR OPENING SO THAT NEW METAL CASING WILL COVER DEMOLITION LINE AT NEW DOORS WITHOUT SUBSTANTIAL FINISH REPAIR
- 4 PROVIDE GYPCRETE LAYER OVER (E) SLAB TO PROVIDE LEVEL TRANSITION FROM LOBBY TO (N) SLAB AT NEW RESTROOM (SEE STRUCTURAL DETAILS FOR MORE INFORMATION)
- 5 APPROXIMATE TRENCH LINE FOR NEW UTILITIES - (B)ORE UNDER SLAB AT TILE FINISH IN LOBBY) SEE PLUMBING PLANS FOR MORE INFORMATION. ALL TRENCH PATCH WORK TO MATCH EXISTING FINISHES.
- 6 REMOVE BENCH IN LOBBY, SALVAGE, AND DELIVER TO OWNER.
- 7 REMOVE FINISHES AT INTERIOR FACE OF (E) WALL IN RESTROOM UP TO ROPE TILE TRANSITION LEVEL (PER INTERIOR ELEVATIONS) AND PREPARE TO RECEIVE TILE FINISH. (SEE RESTROOM FINISH DETAIL ON SHEET A1.1-3) DEMOLISH OR CUT BACK THICKENED WALL SECTION BELOW (E) LEDGE ON (E) WALL AS REQUIRED AND REBUILD WITH MINIMUM 2" FRAMING IN ORDER TO PROVIDE FLUSH WALL FACE TO CEILING.

SPECIAL NOTE:
DEMOLITION PLAN IS SIMILAR AT
ALTERNATE - UNISEX RESTROOM #2.

SPECIAL NOTE:
TRENCH PREPARATION FOR NEW WASTE A
LINES FROM BATHROOM TO (E) LATERAL A
TO BE PROVIDED BY OWNER. PLUMBER TO
NEW LINES IN TRENCH PROVIDED AND THE
TO PROVIDE ALL TRENCH BACKFILL, COMP.
AND FINISHES PER CONTRACT DRAWINGS

CODE REVIEW NARRATIVE:

THE SCOPE OF THIS PROJECT INCLUDES VOLUNTARY ADA UPGRADES IN ORDER TO REMOVE ARCHITECTURAL BARRIERS AND INCREASE ADA ACCESSIBILITY. THE OWNER IS VOLUNTARILY PROVIDING ADA ACCESSIBLE RESTROOMS ON THE GROUND FLOOR WHERE NONE EXISTED BEFORE. BECAUSE ALL UPGRADES ARE VOLUNTARY AND CONSIST OF ADA IMPROVEMENTS, NO FURTHER CODE REVIEW IS REQUIRED BEYOND CODE COMPLIANCE OF ACCESSIBILITY FEATURES IN THE RESTROOMS THEMSELVES.

KEY PLAN NOTES


- 1 AT THIS LOCATION, G.C. TO REMOVE CABINET BACK TO CORNER AS ILLUSTRATED ON PLAN AND IN ELECTRICAL PLANS AND ELEVATIONS.
- 2 PROVIDE NEW DOORS AND CABINET FACE AT LIMITS OF CABINetry DEMOLITION. PROVIDE ALL NECESSARY ALTERATIONS TO COUNTERTOP, BACKSPLASH, AND CABINetry IN ORDER TO MATCH (E) FINISHES AND FUNCTIONALITY. PROVIDE FRP PANEL OR SIMILAR FINISH TO MATCH EXISTING AT LIMITS OF DEMOLITION AT WALL. VERIFY PANEL, CLEARANCES WITH ELECTRICAL ENGINEER/ELECTRICIAN PRIOR TO CONSTRUCTION.
- 3 SEE MECHANICAL PLANS FOR LOCATION OF 8" EXHAUST VENT IN CORNER OF PROJECT ROOM (ABOVE, G.C. TO PROVIDE UNFRAMED BOX-OUT AROUND VENT AND MATCH ADJACENT FINISHES. 1/2" GYP WITH TAPE, TEXTURE, AND PAINT AT A MINIMUM)
- 4 COORDINATE STAGING AREA AT REAR OF BUILDING WITH OWNER PRIOR TO CONSTRUCTION. ALL ACCESS MUST BE MAINTAINED DURING CONSTRUCTION FOR FIRE AND LIFE-SAFETY REASONS AND FOR DELIVERY ACCESS TO REAR OF ADJACENT BUILDINGS.

PROJECT NOTES:

GENERAL INFORMATION:

1. VERIFY ALL DIMENSIONS PRIOR TO CONSTRUCTION. NOTIFY ENGINEER WHERE DISCREPANCIES OCCUR.
2. G.C. SHALL COORDINATE ALL NON-BID ITEMS (INTERIOR FINISH COLORS ETC.) W/ OWNER PRIOR TO CONSTRUCTION IF NOT SPECIFIED IN THESE PLANS.
3. G.C. SHALL PROVIDE ALL APPROPRIATE BACKING, FASTENERS, AND CONCRETE FASTENERS AS REQUIRED FOR BATHROOM ACCESSORIES AND OTHER MISCELLANEOUS ITEMS.
4. G.C. TO COORDINATE INSTALLATION OF ALL UTILITIES W/ RESPECTIVE SUPPLIERS/SUBCONTRACTORS PRIOR TO CONSTRUCTION. TYPICAL.
5. VERIFY (E) UTILITY LAYOUT, AND SAWCUT FOR (N) UTILITIES AS REQUIRED.
6. G.C. SHALL PROVIDE FULLY FURNISHED AND FINISHED RESTROOM FACILITY. G.C. TO COORDINATE WITH OWNER FOR COLOR SELECTION WHERE REQUIRED.
7. G.C. TO IDENTIFY AND REMEDIATE HAZARDOUS MATERIALS.
8. SEE ADDITIONAL NOTES ON PLAN SET FOR FURTHER INFORMATION.
9. G.C. TO PROVIDE MATERIAL SUBMITTALS FOR ALL FINISHES PRIOR TO START OF CONSTRUCTION, FOR ALL FINISHES THAT REQUIRE FIELD PAINTING, STAINING, OR OTHER MODIFICATION OF INSTALLED FEATURES. G.C. TO SUBMIT MOCK-UP OF FINAL PRODUCT PRIOR TO FINAL APPROVAL AND INSTALLATION.
10. SAMPLES SHALL BE SUBMITTED IN A TIMELY MANNER IN ORDER TO ALLOW OWNER ADEQUATE TIME FOR REVIEW AND APPROVAL. G.C. TO ALLOW A MINIMUM OF 1 WEEK FOR REVIEW AFTER SUBMITTAL.

SPECIAL NOTE:
G.C. TO TAKE ALL NECESSARY STEPS/PRECAUTIONS IN ORDER
TO PROTECT ALL FEATURES OF EXISTING BUILDING THAT ARE
TO REMAIN IN AREAS OF CONSTRUCTION AND ALL FEATURES IN
OTHER AREAS. PROTECT ALL FEATURES FROM DAMAGE DUE
TO MATERIALS STORAGE AND HANDLING AS WELL AS ACCESS.

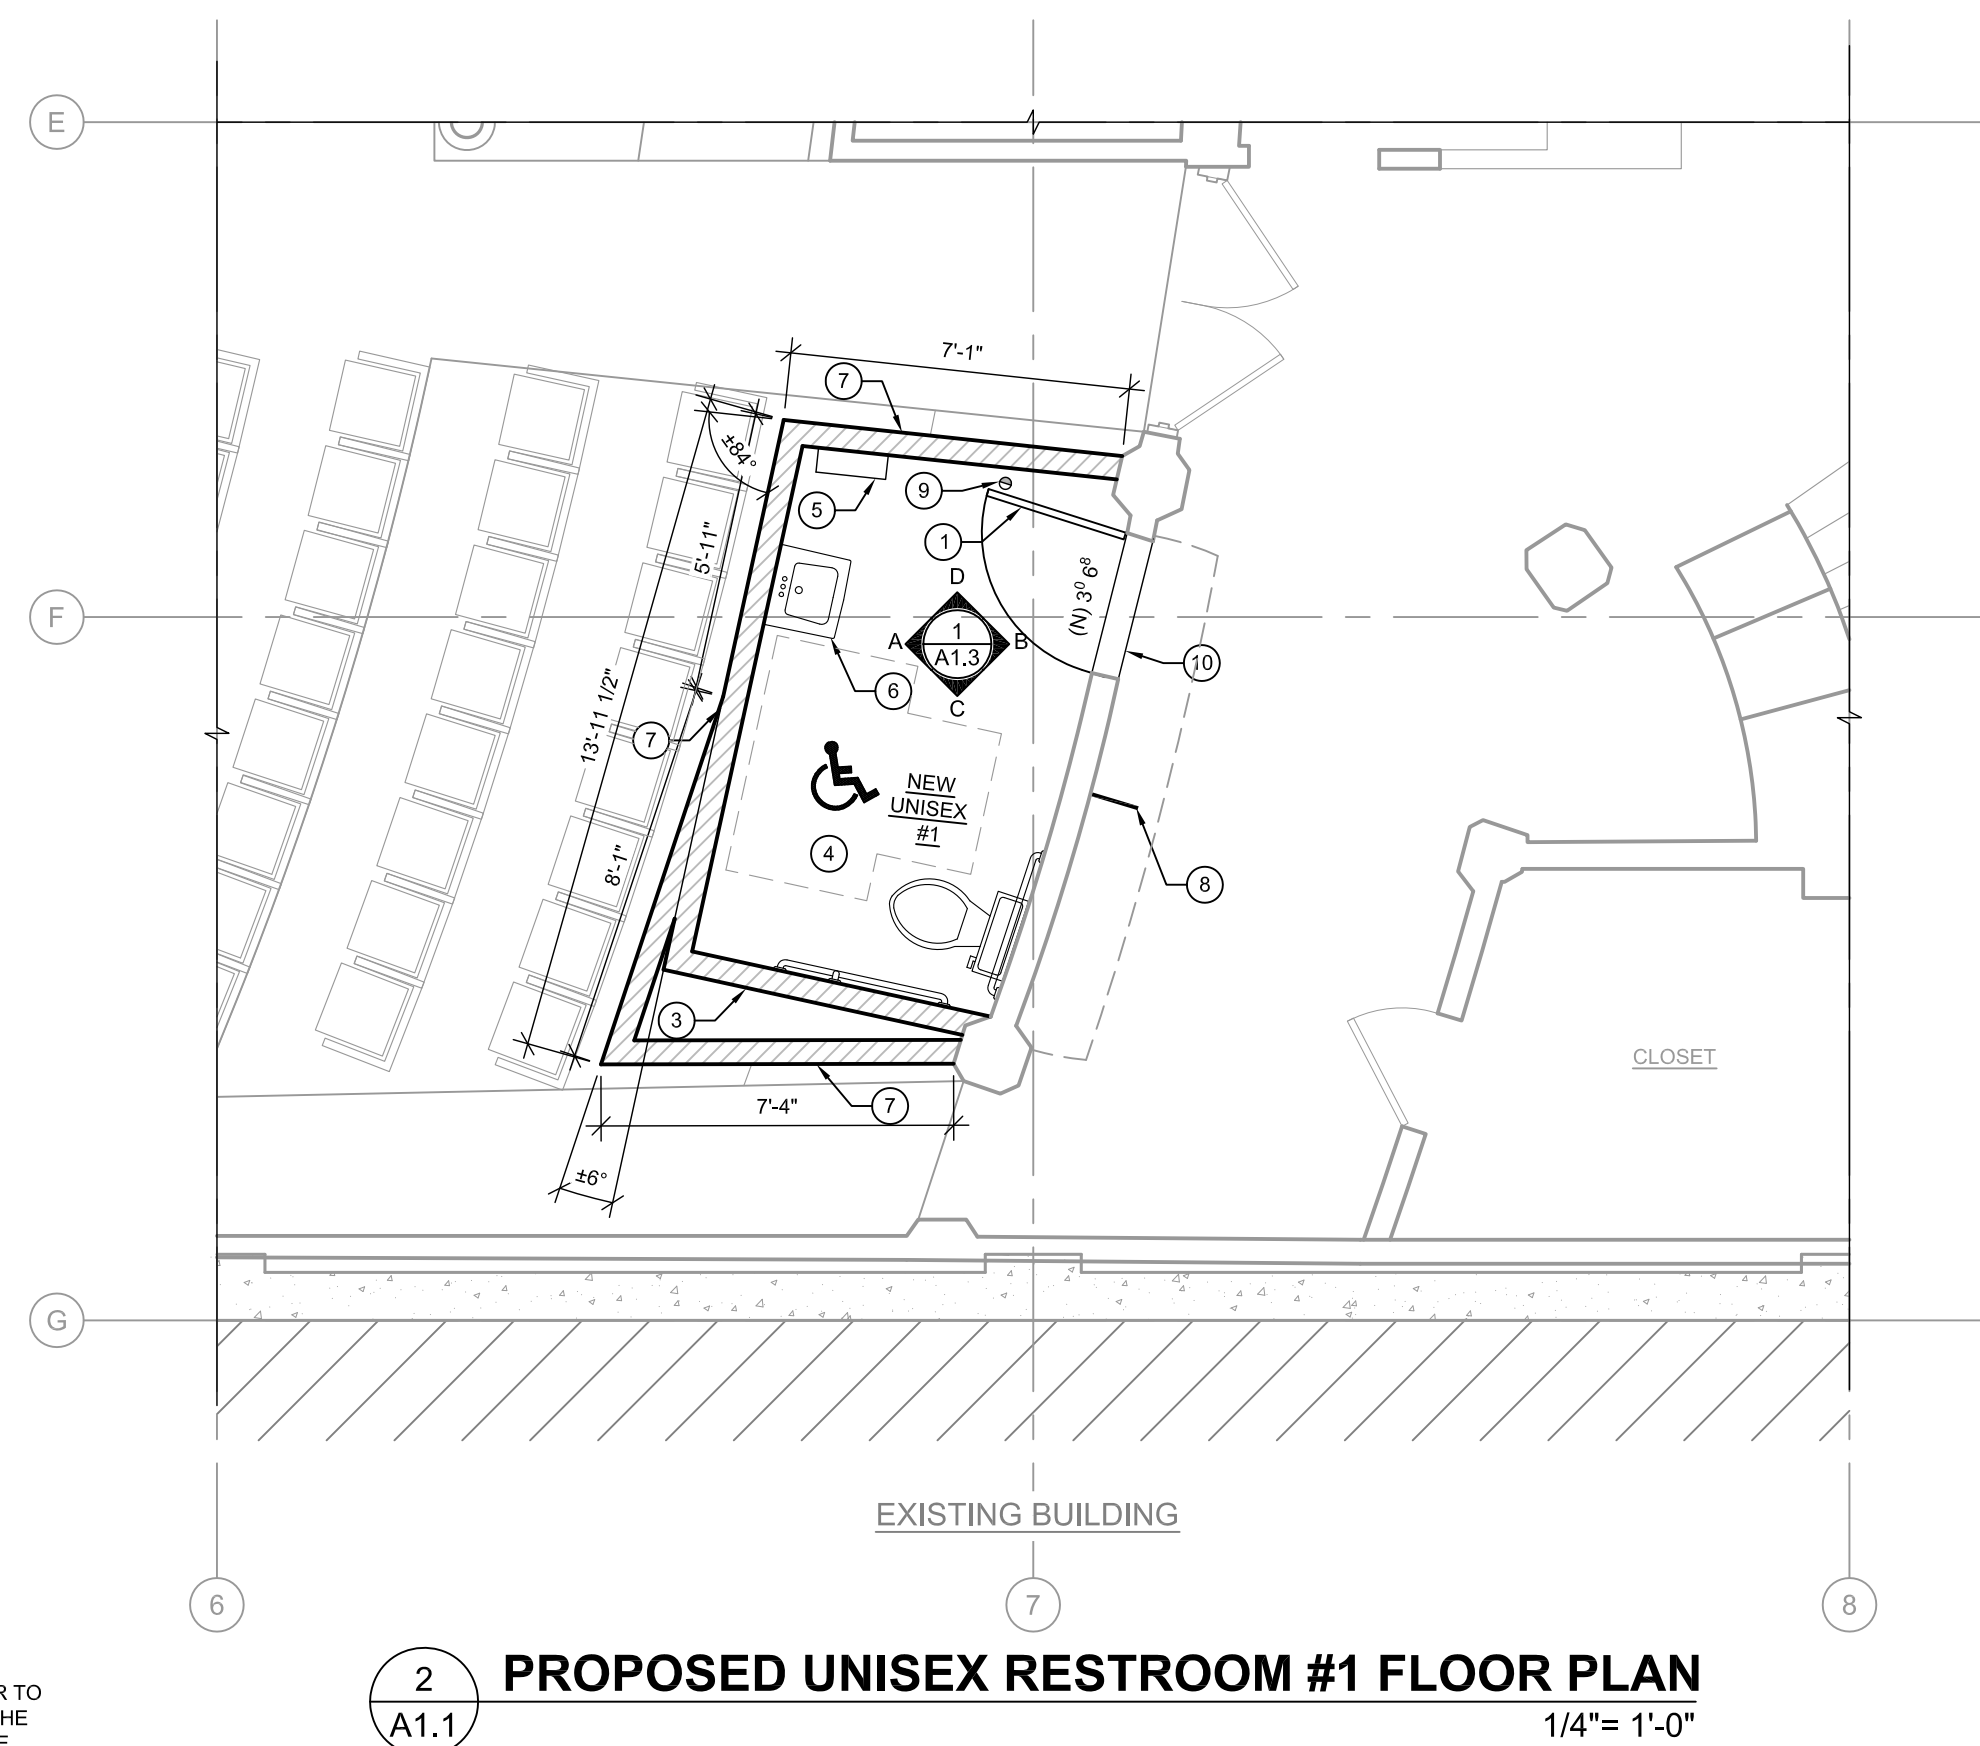

- ### RESTROOM PLAN KEYED NOTES


- ① SOLID WOOD CORE DOOR, SEE INTERIOR ELEVATIONS. PROVIDE WEATHER STRIPPING AT DOOR SOUND TRANSMISSION MITIGATION.
- ② NAIL WALL W/ STAGGERED 2x4 STUDS @ 8" O.C. (2 WALLS AT 16" O.C. - SEE STRUCTURAL) WITH DOUBLE LAYER OF 1/2" TYPE X GYPSUM BOARD EACH SIDE AND "FIBERGLAS PLINK" OR APPROVED EQUAL ACQUANT INSULATION (COMPLETELY FILL JOINTS). TYP. SEE DETAILS AND INTERIOR ELEVATION FOR MORE INFORMATION.
- ③ AT DOUBLE WALL LOCATIONS PROVIDE 2x6 @ 16" O.C. SINGLE STUD WALLS WHERE SHOWN W/ FINISHES AS STATED ABOVE ON OUTSIDE FACE ONLY (FILL CAVITY WITH INSULATION AS STATED IN NOTE 2). C.C. OPTION - G.C. MAY PROVIDE SINGLE LAYER OF 1/2" GYP OR OTHER APPROVED FINISH KEEPING INSULATION TIGHT ON HIDDEN WALL FACES AND LEAVE CAVITY BETWEEN WALLS EMPTY.
- ④ TILE OVER CONCRETE FLOOR, SEE INTERIOR ELEVATIONS.
- ⑤ COMBINATION TRASH RECEPTACLE/TOWEL DISPENSER, (SEE INTERIOR ELEVATIONS)
- ⑥ NEW PLUMBING FIXTURE, TYP. SEE PLUMBING PLANS.
- ⑦ AT EXTERIOR SIDES OF NEW WALLS, PROVIDE RED PATTERNER CARPET TO MATCH (E) OVER PORTION OF WALL. G-LUG MATCH ELEVATION OF FINISHES ON CONCESSION WALL TO MATCH SEAMS (E) ON WALL TO MATCH (E) AT EXTERIOR OF CONCESSION WALL, AT BTM. OF WALL AND AT TOP OF CARPET PROVIDE PAINTED BATTEN TO MATCH EXISTING AT CONCESSION WALL, PROVIDE SKIM COAT FINISH TO MATCH (E) CONCESSION WALL ABOVE CARPET LEVEL TO CEILING. PROVIDE SAMPLE OF CARPET, MOCK UP OF TEXTURED FINISH AND MOCK UP OF BATTEN WITH PAINT FOR APPROVAL PRIOR TO CONSTRUCTION.
- ⑧ PROVIDE NEW PERPENDICULAR OVERHEAD REESTROOM SIGN AT (E) WALL BETWEEN REESTROOMS AS SHOWN (COORDINATE COLOR WITH OWNER PRIORITY TO CONSTRUCTION).
- ⑨ PROVIDE NEW FLOOR-MOUNTED DOOR STOP WITH RUBBER BUMPER AT APPROXIMATE LOCATIONS SHOWN ON PLAN. (DOOR TO STOP CLEAR OF WALL)
- ⑩ PROVIDE NEW ALUMINUM TRANSITION (BLACK) AT BTM. OF DOOR AT THRESHOLD, PROVIDE TRANSITION WIDTH SUFFICIENT TO COVER ENTIRE THRESHOLD TO SO THAT EACH TILE FINISH IS NOT SEEN FROM THE OPPOSITE SIDE OF THE DOOR (MIN. 10").


NOTE: G.C. TO PROVIDE ALL ADA SIGNAGE AS REQUIRED BY CODE INCLUDING BUT NOT LIMITED TO: ADA WALL PLACARD WITH BRAILLE IDENTIFICATION, GEOMETRIC DOOR SIGN, AND DOOR HARDWARE WITH OCCUPANCY INDICATOR (COORDINATE COLOR WITH OWNER PRIOR TO CONSTRUCTION).

ALTERNATE RESTROOM PLAN KEYED
NOTES

- ① SOLID WOOD CORE DOOR. SEE INTERIOR ELEVATIONS. PROVIDE WEATHER STRIPPING AT DOOR FOR SOUND TRANSMISSION MITIGATION.
- ② WALL W/ STAGGERED 2x4 STUDS @ 8" O.C., 2 WALLS AT 16" O.C. - SEE STRUCTURAL WITH DOUBLE LAYER OF 1/2" TYPE X GYPSUM BOARD EACH SIDE AND "FIBERGLAS PINK" OR RED DENSE SOUND/Acoustic INSULATION (COMPLETELY FILL CAVITY) TYP. SEE DETAILS AND INTERIOR ELEVATION FOR MORE INFORMATION.
- ③ AT DOUBLE WALL LOCATIONS PROVIDE 2x6 @ 16" O.C. SINGLE STUD WALLS WHERE SHOWN W/ FINISHES AS STATED ABOVE ON OUTSIDE FACE ONLY (FILL CAVITY WITH INSULATION AS STATED IN NOTE 2) G.C. OPTION - C.G. MAY PROVIDE SINGLE LAYER OF 1/2" GYP OR OTHER APPROVED MEANS OF KEERING INSULATION TIGHT ON HIDDEN WALL FACES AND LEAVE CAVITY BETWEEN WALLS EMPTY.
- ④ TILE OVER CONCRETE FLOOR. SEE INTERIOR ELEVATIONS.
- ⑤ COMBINATION TRASH RECEPTACLE/TOWEL DISPENSER. (SEE INTERIOR ELEVATIONS)
- ⑥ NEW PLUMBING FIXTURE. TYP. SEE PLUMBING PLANS.
- ⑦ AT EXTERIOR SIDES OF NEW WALLS. PROVIDE RED PATTERNOED CARPET TO MATCH (E) OVER PORTION OF WALL. MATCH COLOR OF FINISHES ON CONCESSION WALL. RUN SEAMS VERTICAL ON WALL TO MATCH (E) AT EXTERIOR OF CONCESSION WALL. AT BTM. OF WALL AND TOP OF CARPET PROVIDE PATTERNOED BATTEN TO MATCH EXISTING CONCESSION CARPET. PROVIDE 3/8" CARPET FINISH TO MATCH (E) CONCESSION WALL ABOVE CARPET LEVEL TO CEILING. PROVIDE SAMPLE OF CARPET, MOCK UP OF TEXTURED FINISH AND MOCK UP OF BATTEN WITH PAINT FOR APPROVAL PRIOR TO CONSTRUCTION.
- ⑧ PROVIDE NEW PERPENDICULAR OVERHEAD RESTROOM SIGN AT (E) WALL BETWEEN RESTROOMS AS SHOWN (COORDINATE COLOR WITH OWNER PRIOR TO CONSTRUCTION).
- ⑨ PROVIDE NEW FLOOR-MOUNTED DOOR STOP WITH RUBBER BUMPER AT APPROXIMATE LOCATIONS SHOWN ON PLAN. (DOOR TO STOP CLEAR OF WALL)
- ⑩ PROVIDE NEW ALUMINUM TRANSITION (BLACK) AT BTM. OF DOOR AT THRESHOLD. PROVIDE TRANSITION WIDTH SUFFICIENT TO COVER ENTIRE THRESHOLD SO THAT EACH TILE FINISH IS NOT SEEN FROM THE OPPOSITE SIDE OF THE DOOR (MIN. 10").


NOTE: G.C. TO PROVIDE ALL ADA SIGNAGE AS REQUIRED BY CODE INCLUDING BUT NOT LIMITED TO: ADA WALL PLACARD WITH BRAILLE IDENTIFICATION, GEOMETRIC DOOR SIGN, AND DOOR HARDWARE WITH OCCUPANCY INDICATOR (COORDINATE COLOR WITH OWNER PRIOR TO CONSTRUCTION).

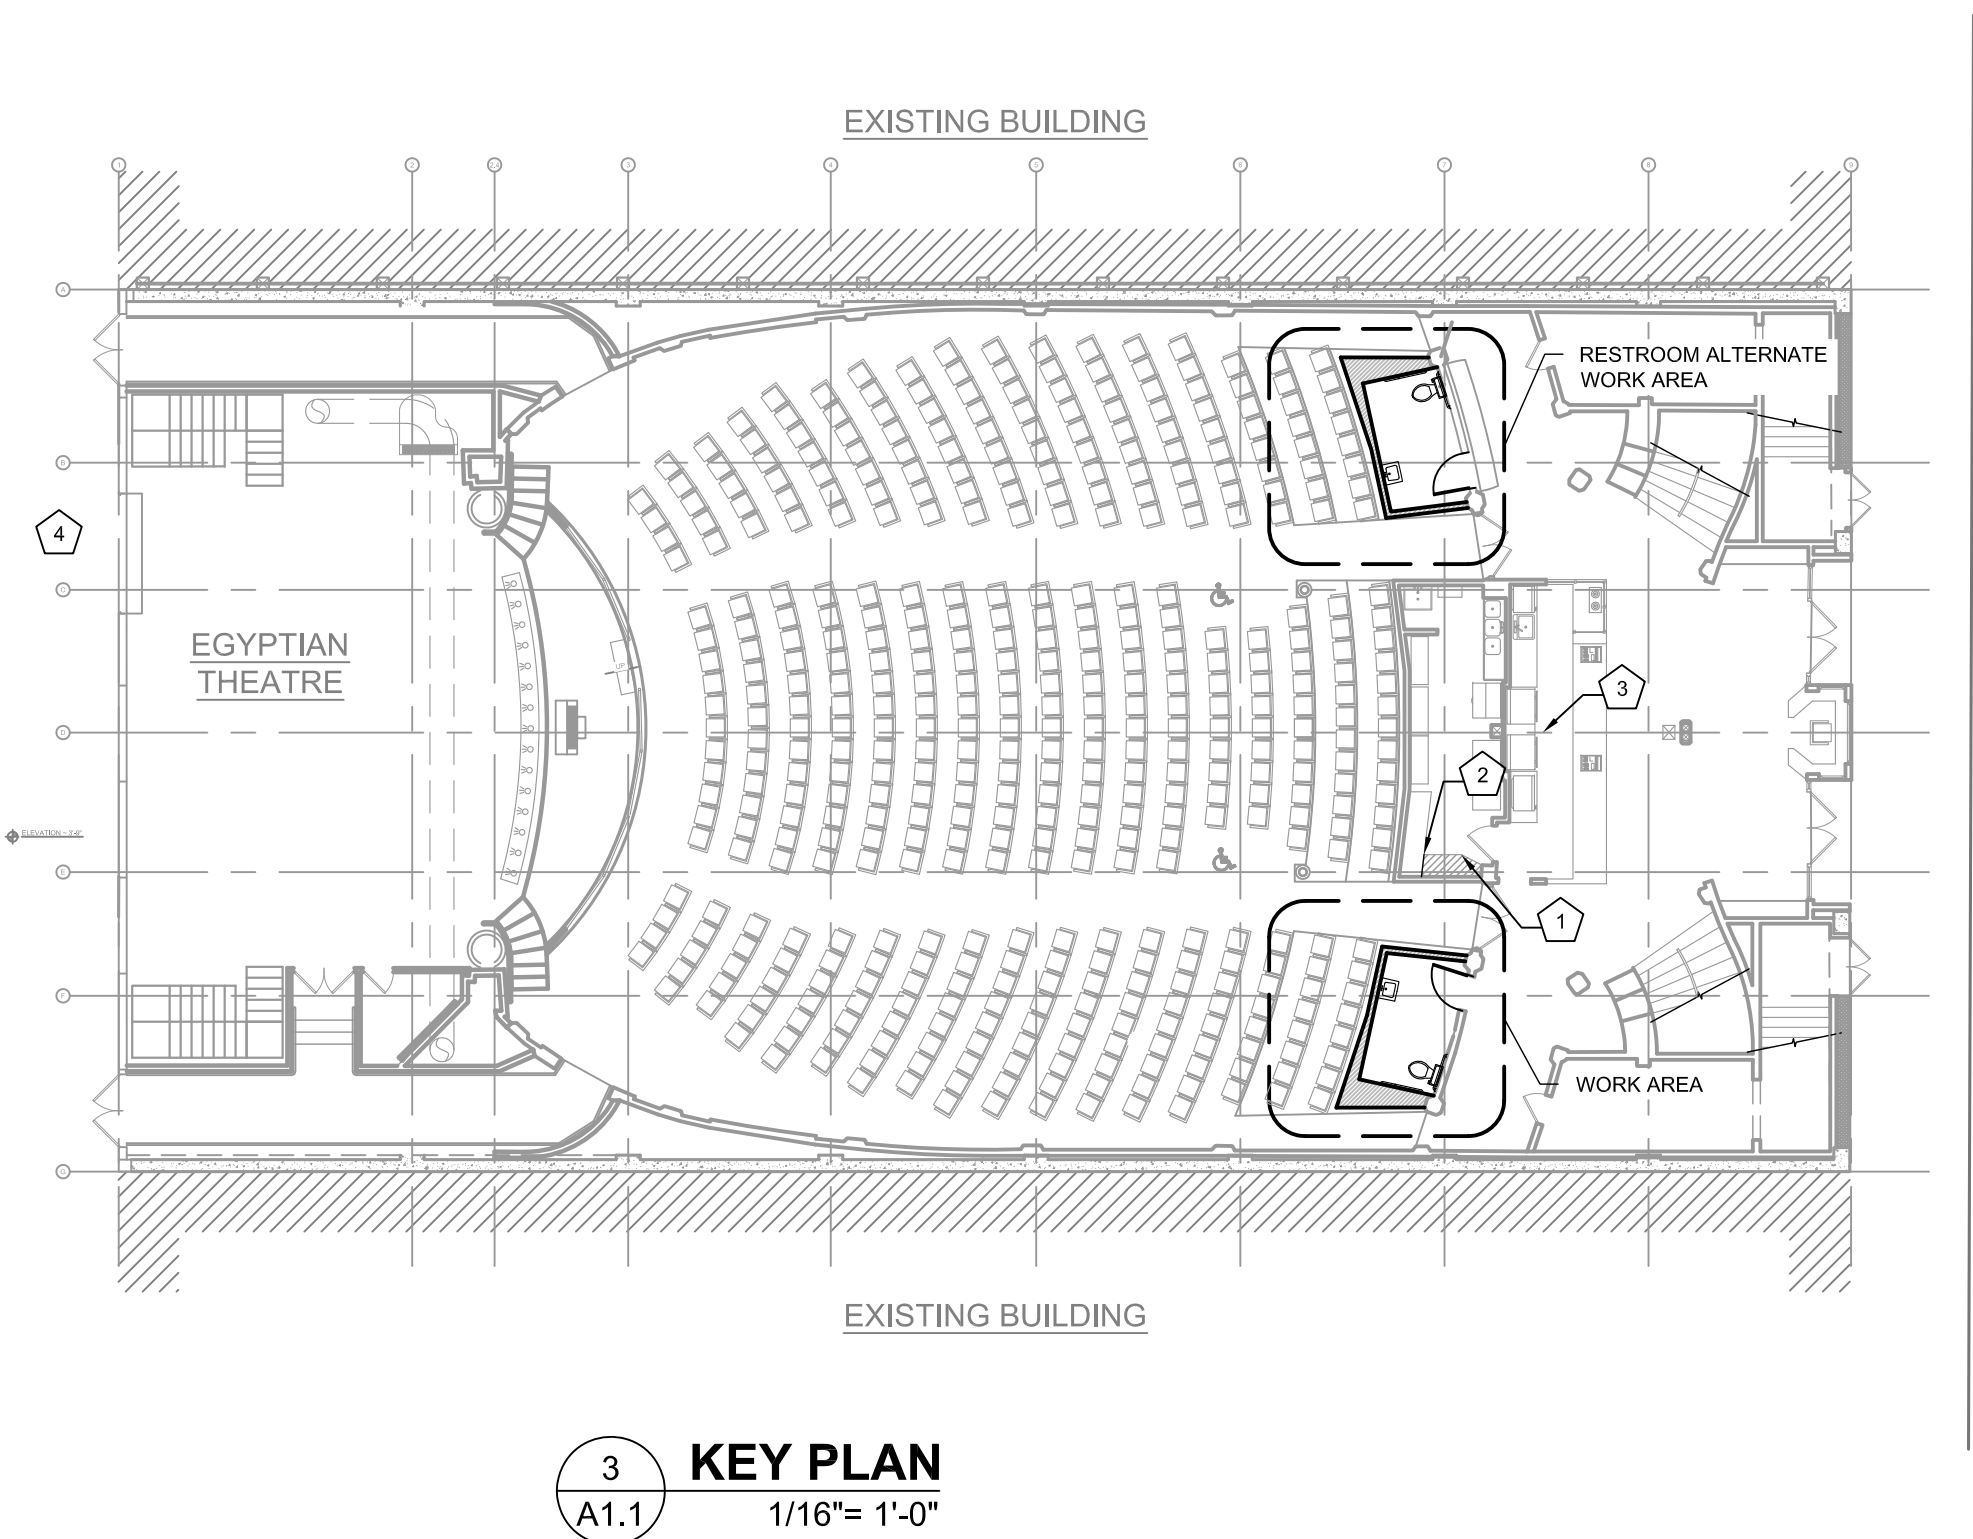

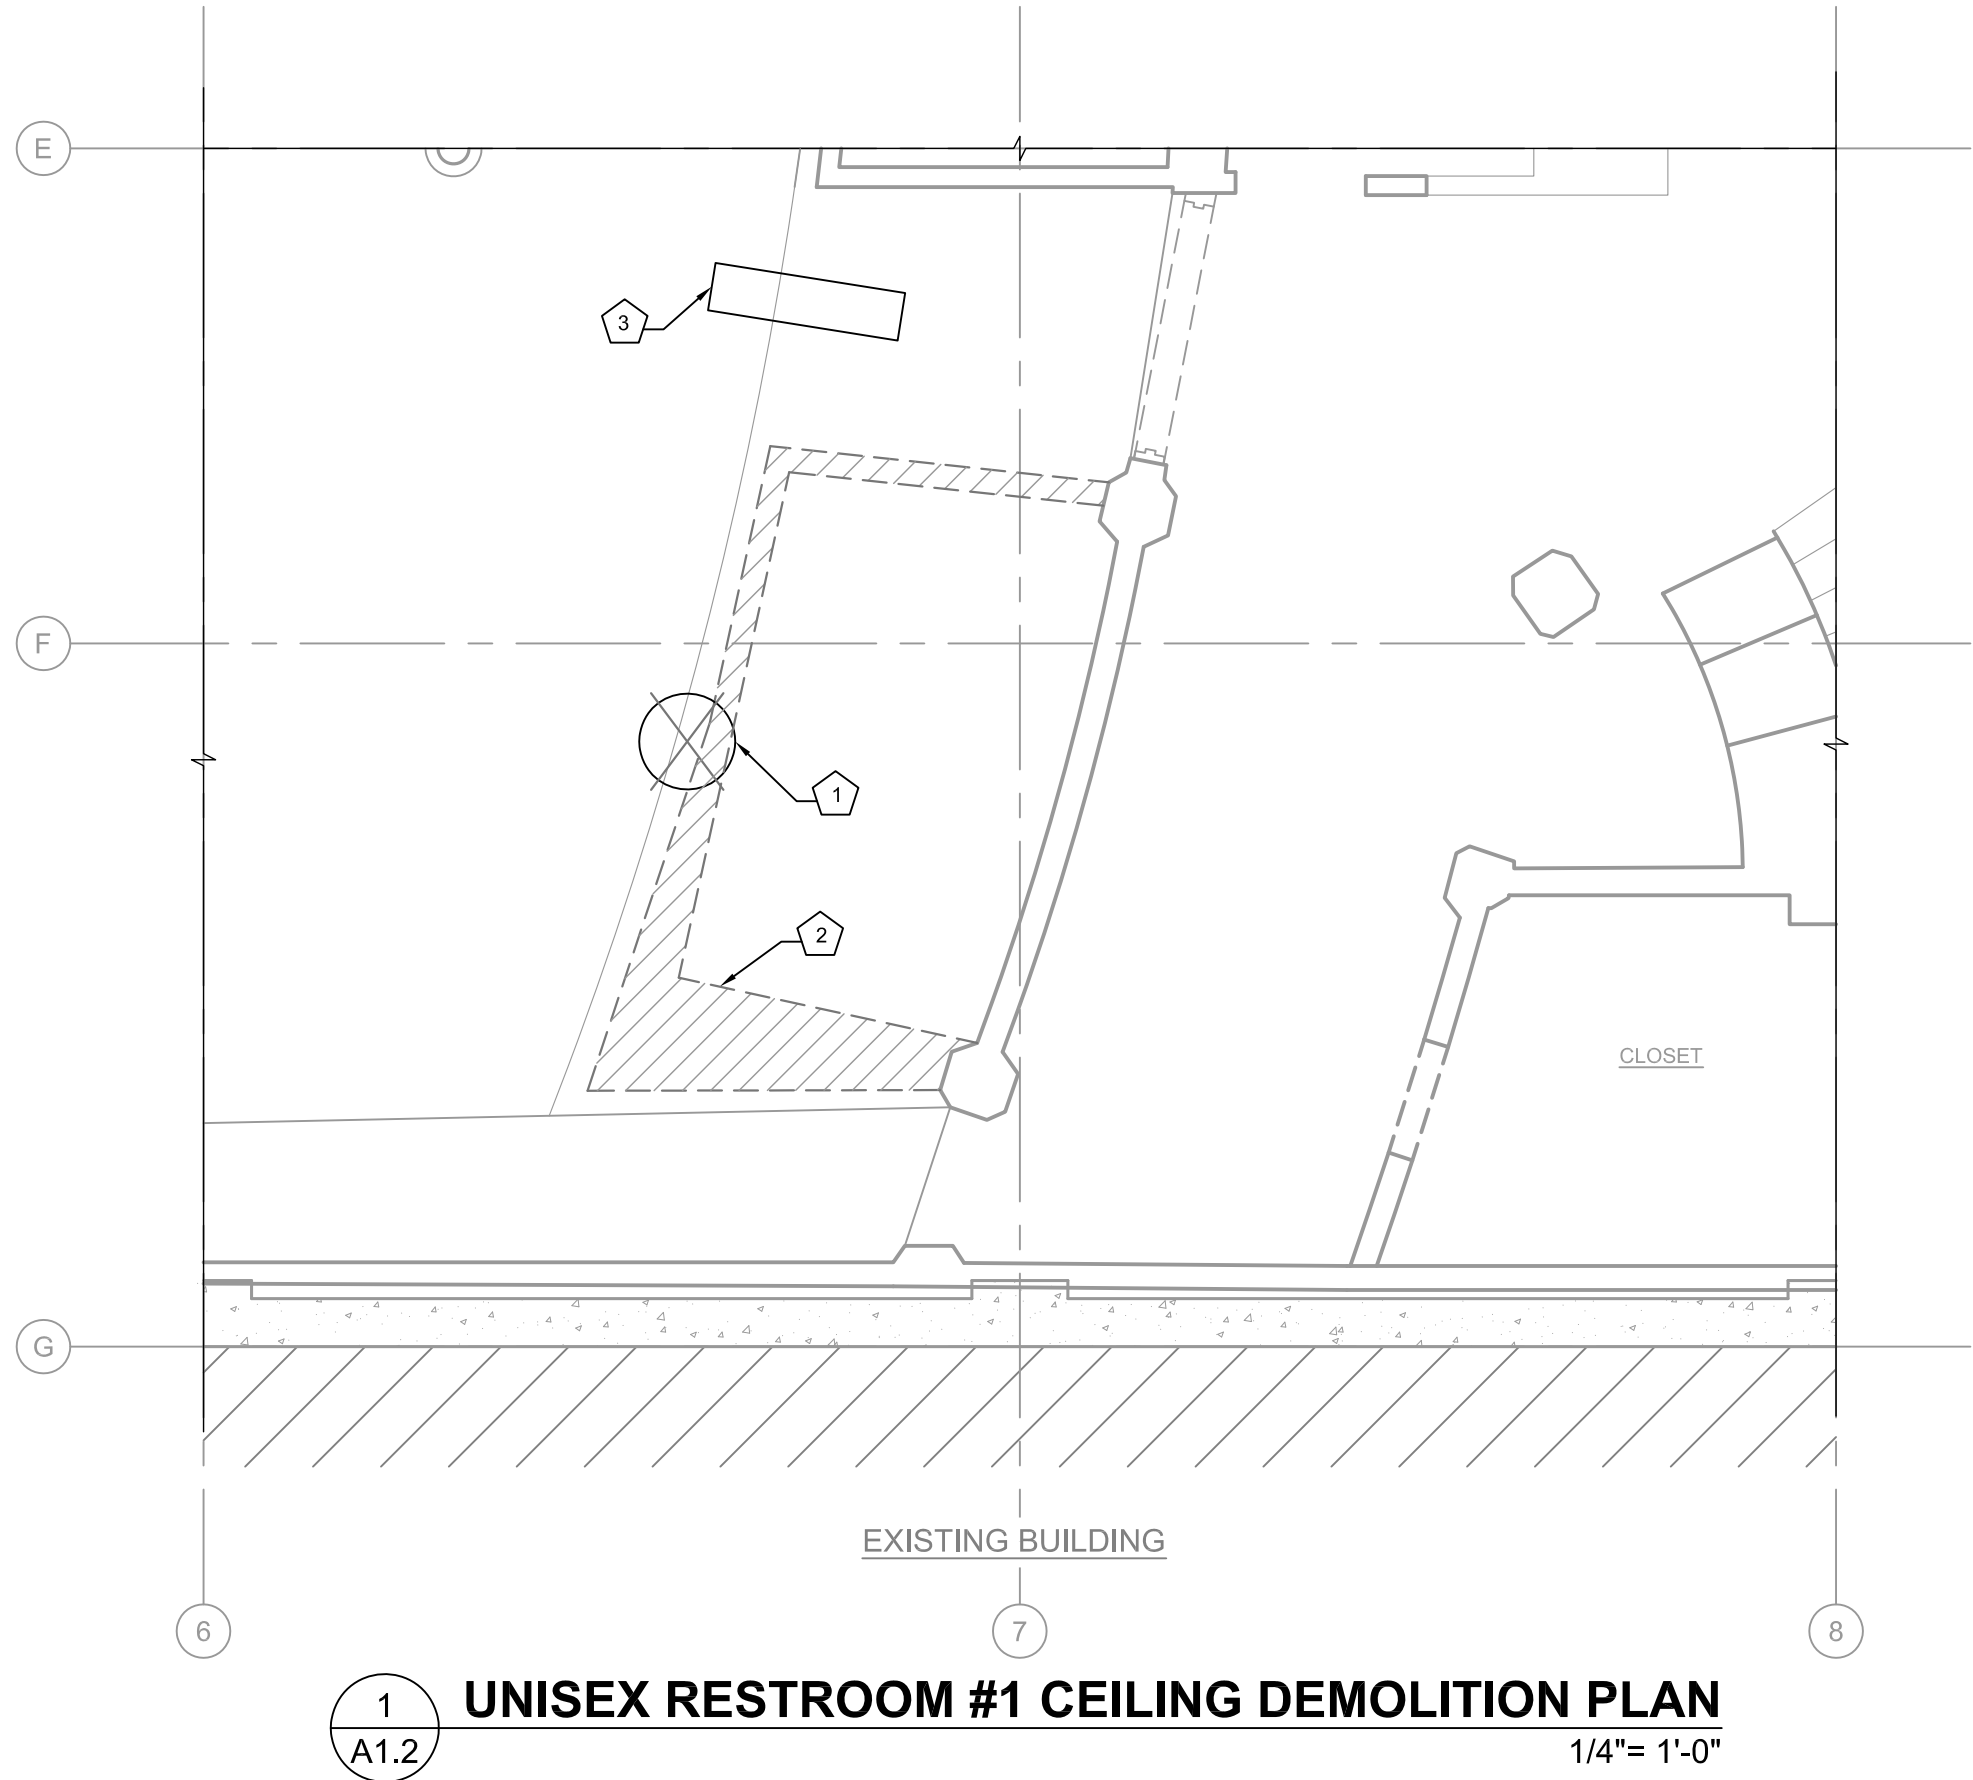


CEILING DEMO PLAN KEYED NOTES

- 1 REMOVE EXISTING SURFACE MOUNTED STYLIZED LIGHT FIXTURE, SALVAGE, AND DELIVER TO OWNER. REINSTALL PER REFLECTED CEILING PLAN. PATCH CEILING FINISHES AS REQ'D AND SUBMIT FINISH MOCK-UP PRIOR TO PATCHING OPERATIONS.
- 2 REMOVE CEILING FINISHES WITHIN LIMITS SHOWN ON PLAN AND IN DETAILS FOR INSTALLATION OF NEW WALLS. COORDINATE INSTALLATION OF ALL UTILITIES PRIOR TO (N) FINISH INSTALLATION.
- 3 G.C. TO VERIFY EXISTING FLUORESCENT LIGHT FIXTURE REMAINS CLEAR OF NEW WALLS. REMOVE AND RELOCATE AS REQ'D TO PROVIDE LIGHT IN NEW HALLWAY. PATCH FINISHES AS REQUIRED AND SUBMIT FINISH MOCK-UP PRIOR TO PATCHING OPERATIONS.

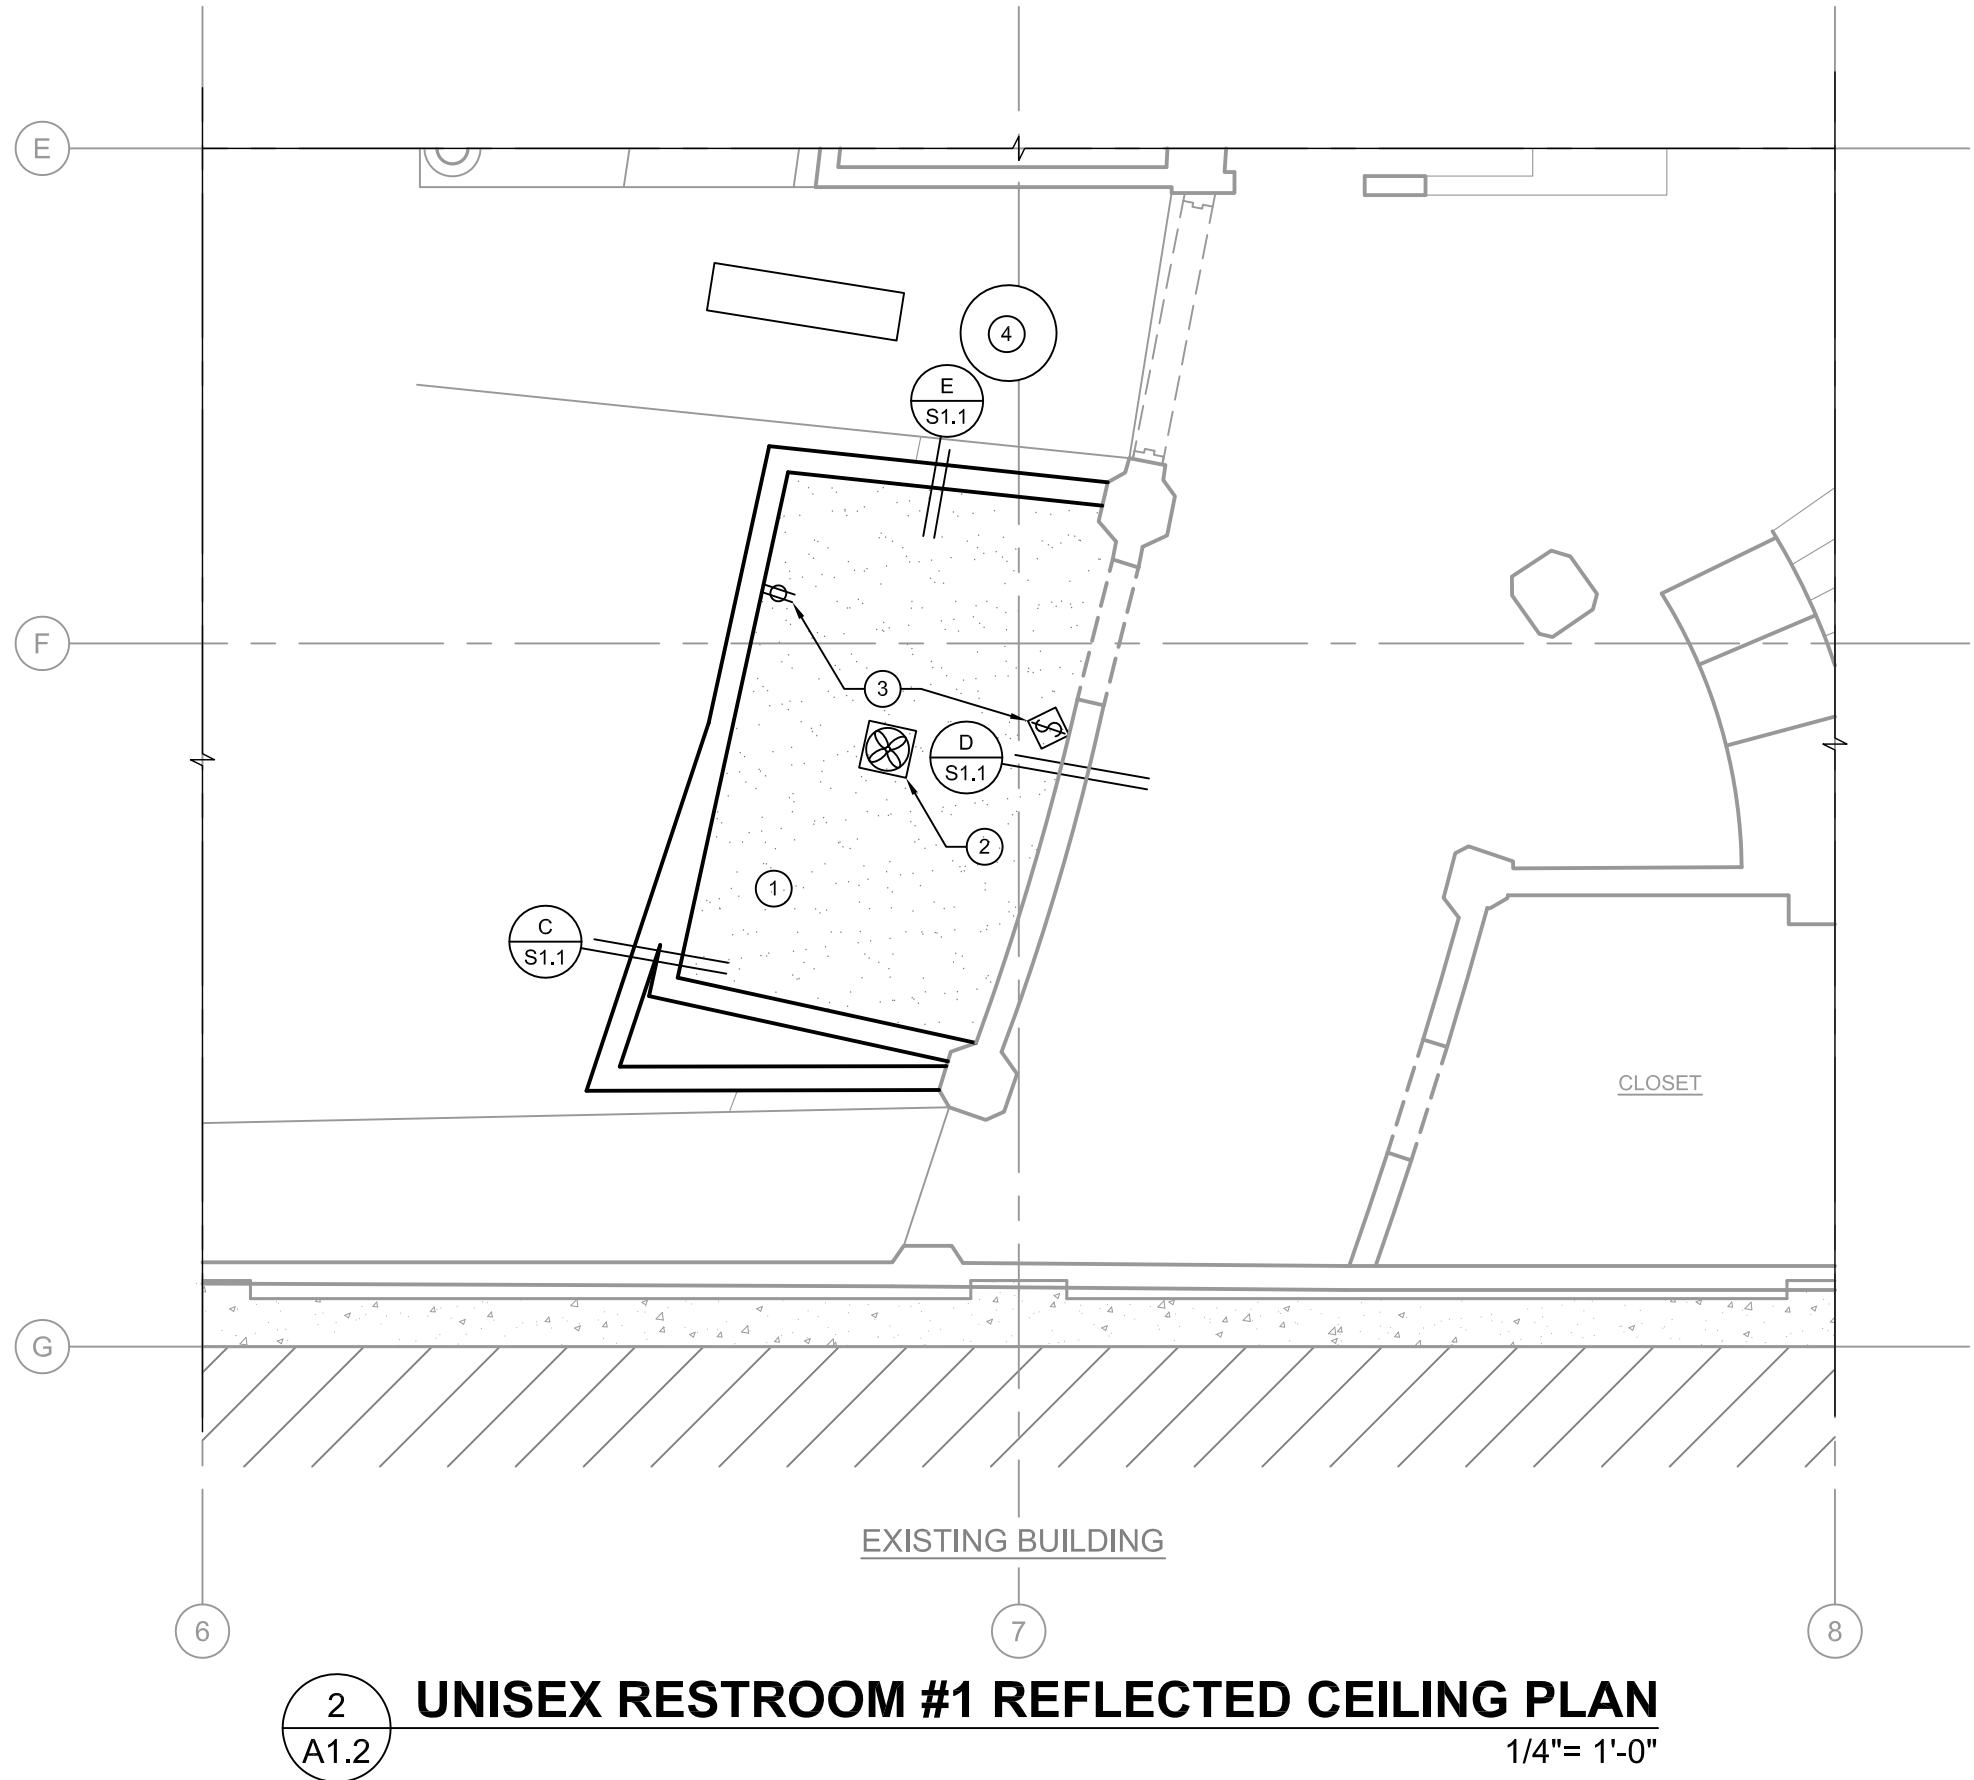


REFLECTED CEILING PLAN KEYED NOTES

- 1 EXISTING CEILING AND FINISHES TO REMAIN. PLACE SINGLE LAYER OF OWENS-CORNING QUIET-ZONE ACOUSTICAL BATTS OR APPROVED EQUAL ABOVE CEILING. PAINT PER INTERIOR ELEVATIONS.
- 2 NEW EXHAUST FAN PER MECHANICAL DRAWINGS (FIELD PREP AND PAINT GRILLE TO MATCH CEILING COLOR - 1 COAT PRIMER AND 2 COATS SATIN LATEX PAINT). MECHANICAL CONTRACTOR TO UTILIZE (E) RETURN AIR OPENING IN (E) CEILING FOR EXHAUST FAN. COORDINATE WITH MECHANICAL PLANS.
- 3 SWITCHING AND POWER PER ELECTRICAL PLANS. PROVIDE WHITE COLOR AT ALL COVERS AND FIXTURES FOR ELECTRICAL.
- 4 REINSTALL SALVAGED PERIOD LIGHTING FIXTURE AT LOCATION SHOWN (FINALIZE LAYOUT WITH OWNER PRIOR TO CONSTRUCTION)

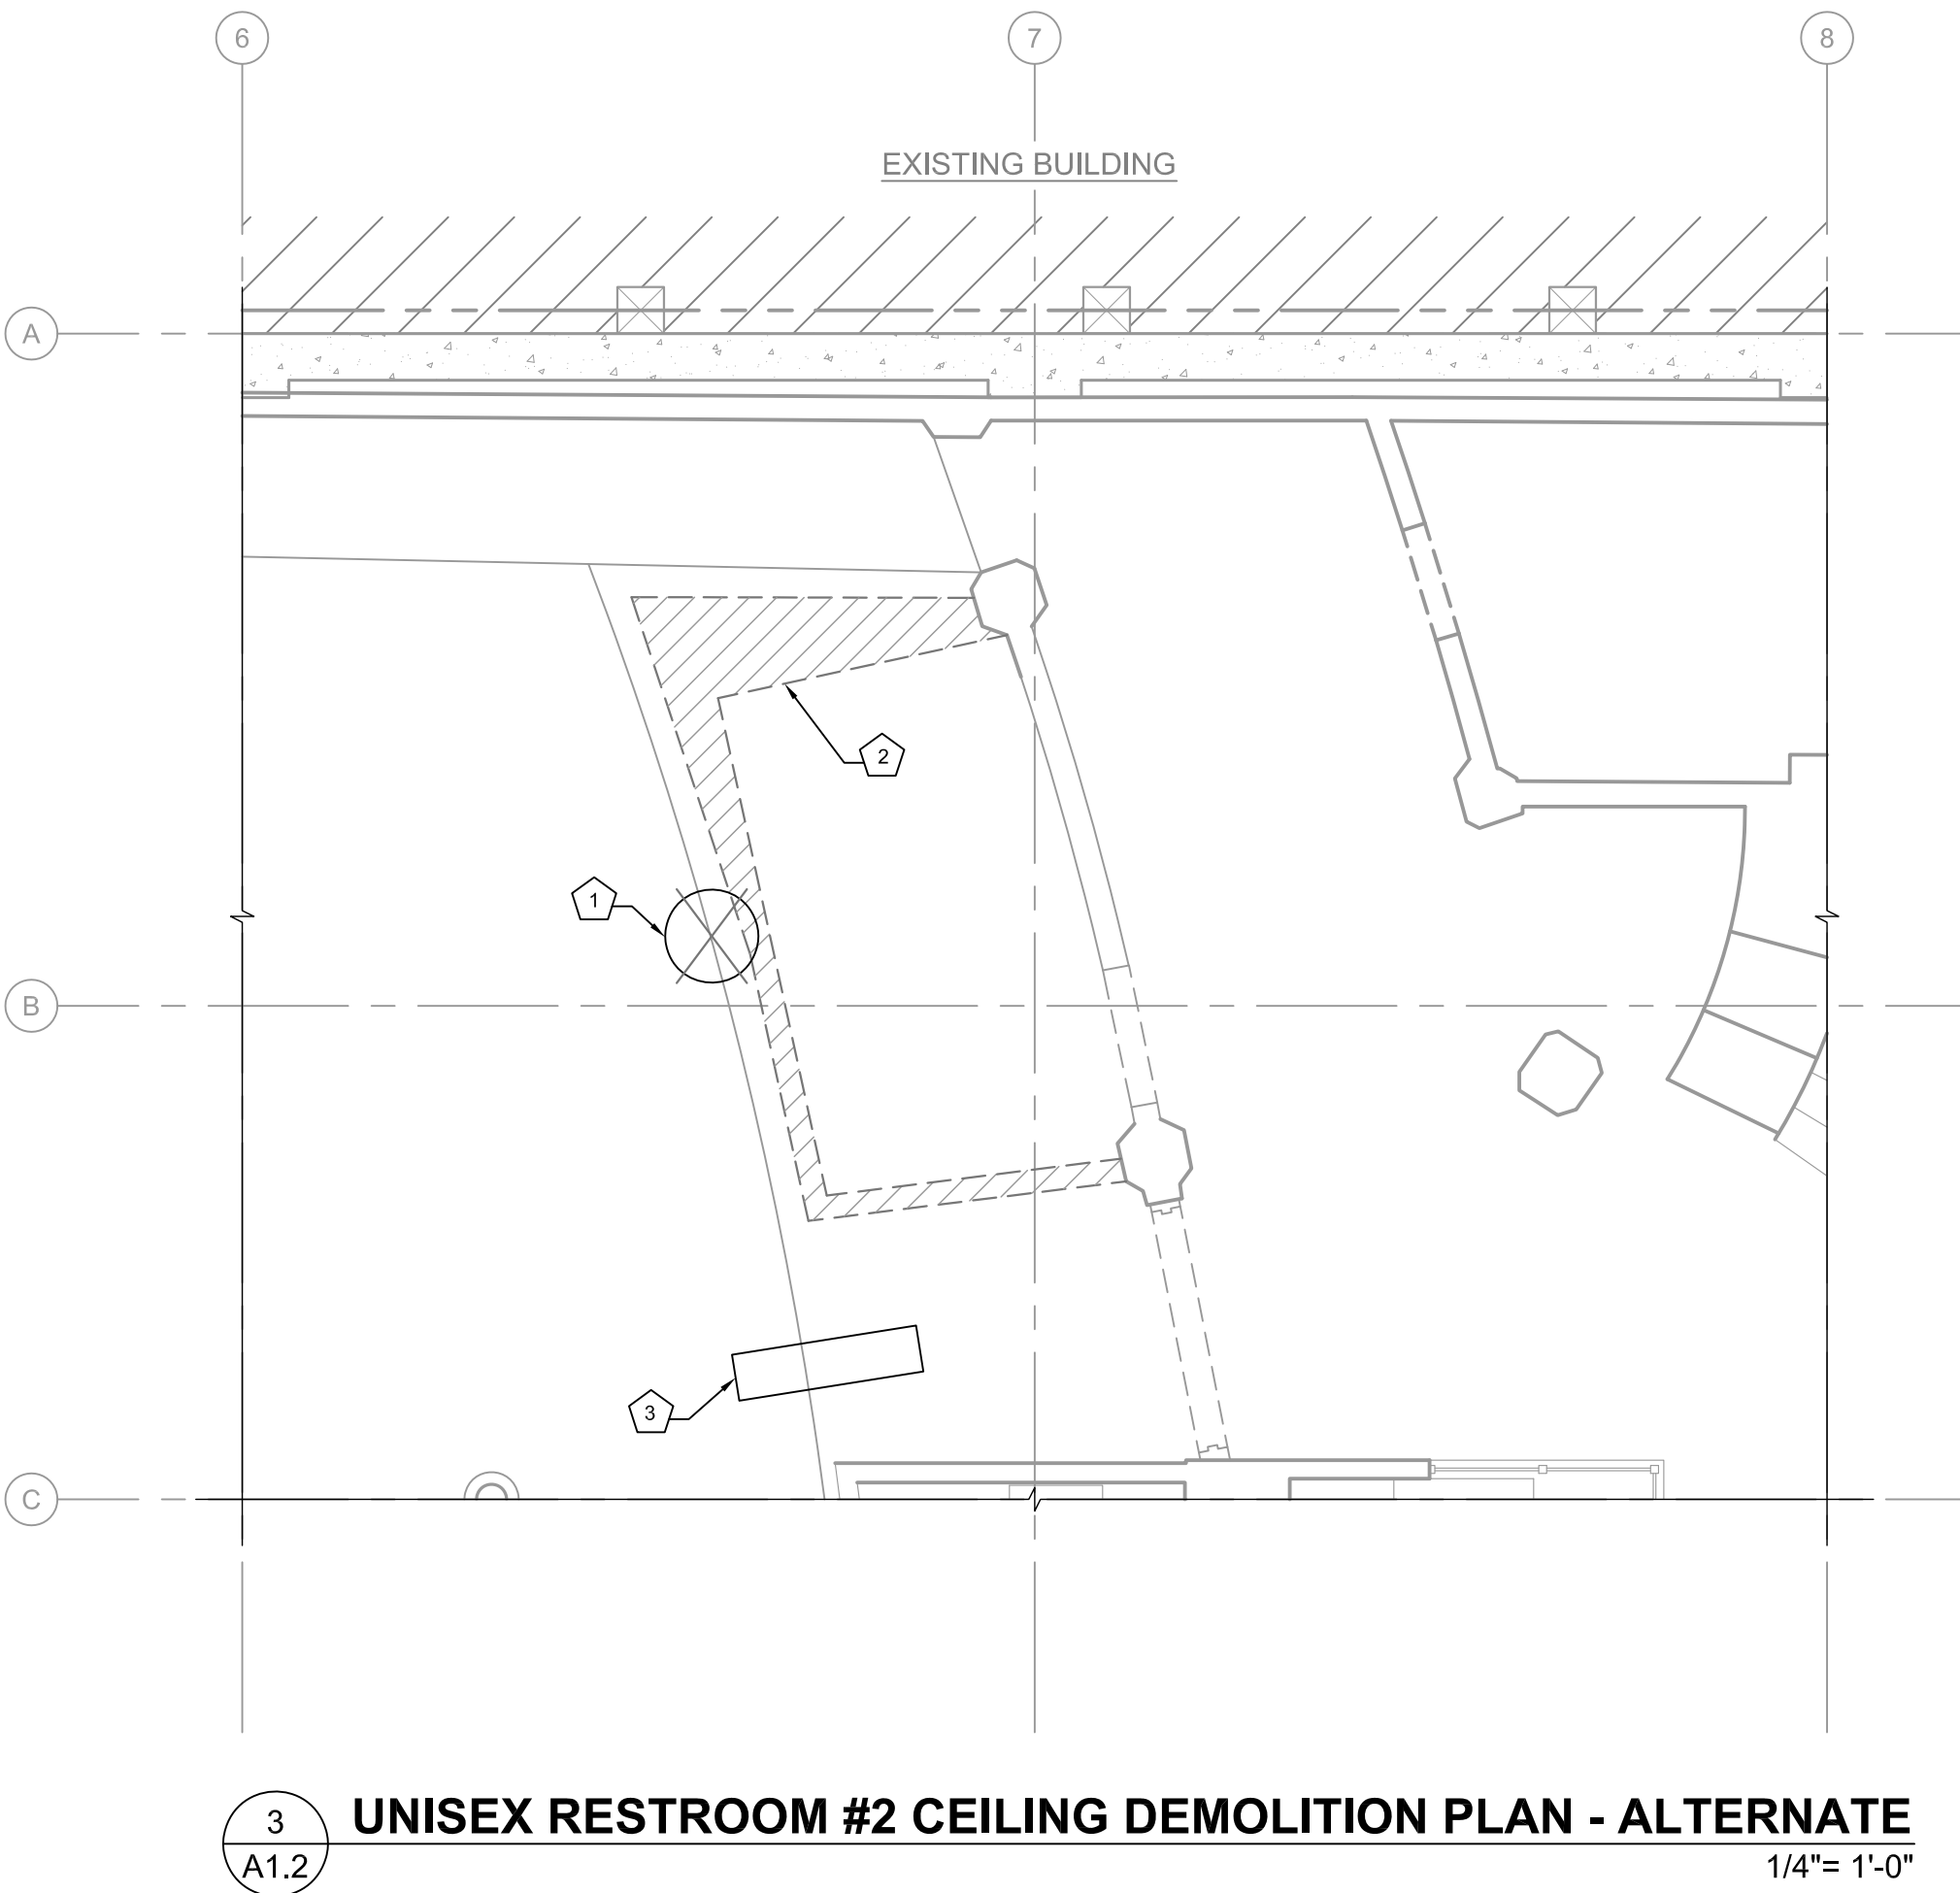

ALTERNATE CEILING DEMO PLAN KEYED NOTES

- 1 REMOVE EXISTING SURFACE MOUNTED STYLIZED LIGHT FIXTURE, SALVAGE, AND DELIVER TO OWNER. REINSTALL PER REFLECTED CEILING PLAN. PATCH CEILING FINISHES AS REQ'D AND SUBMIT FINISH MOCK-UP PRIOR TO PATCHING OPERATIONS.
- 2 REMOVE CEILING FINISHES WITHIN LIMITS SHOWN ON PLAN AND IN DETAILS FOR INSTALLATION OF WALLS. COORDINATE INSTALLATION OF ALL UTILITIES PRIOR TO (N) FINISH RE-INSTALLATION.
- 3 G.C. TO VERIFY EXISTING FLUORESCENT LIGHT FIXTURE REMAINS CLEAR OF NEW WALLS. REMOVE AND RELOCATE AS REQ'D TO PROVIDE LIGHT IN NEW HALLWAY. PATCH FINISHES AS REQUIRED AND SUBMIT FINISH MOCK-UP PRIOR TO PATCHING OPERATIONS.

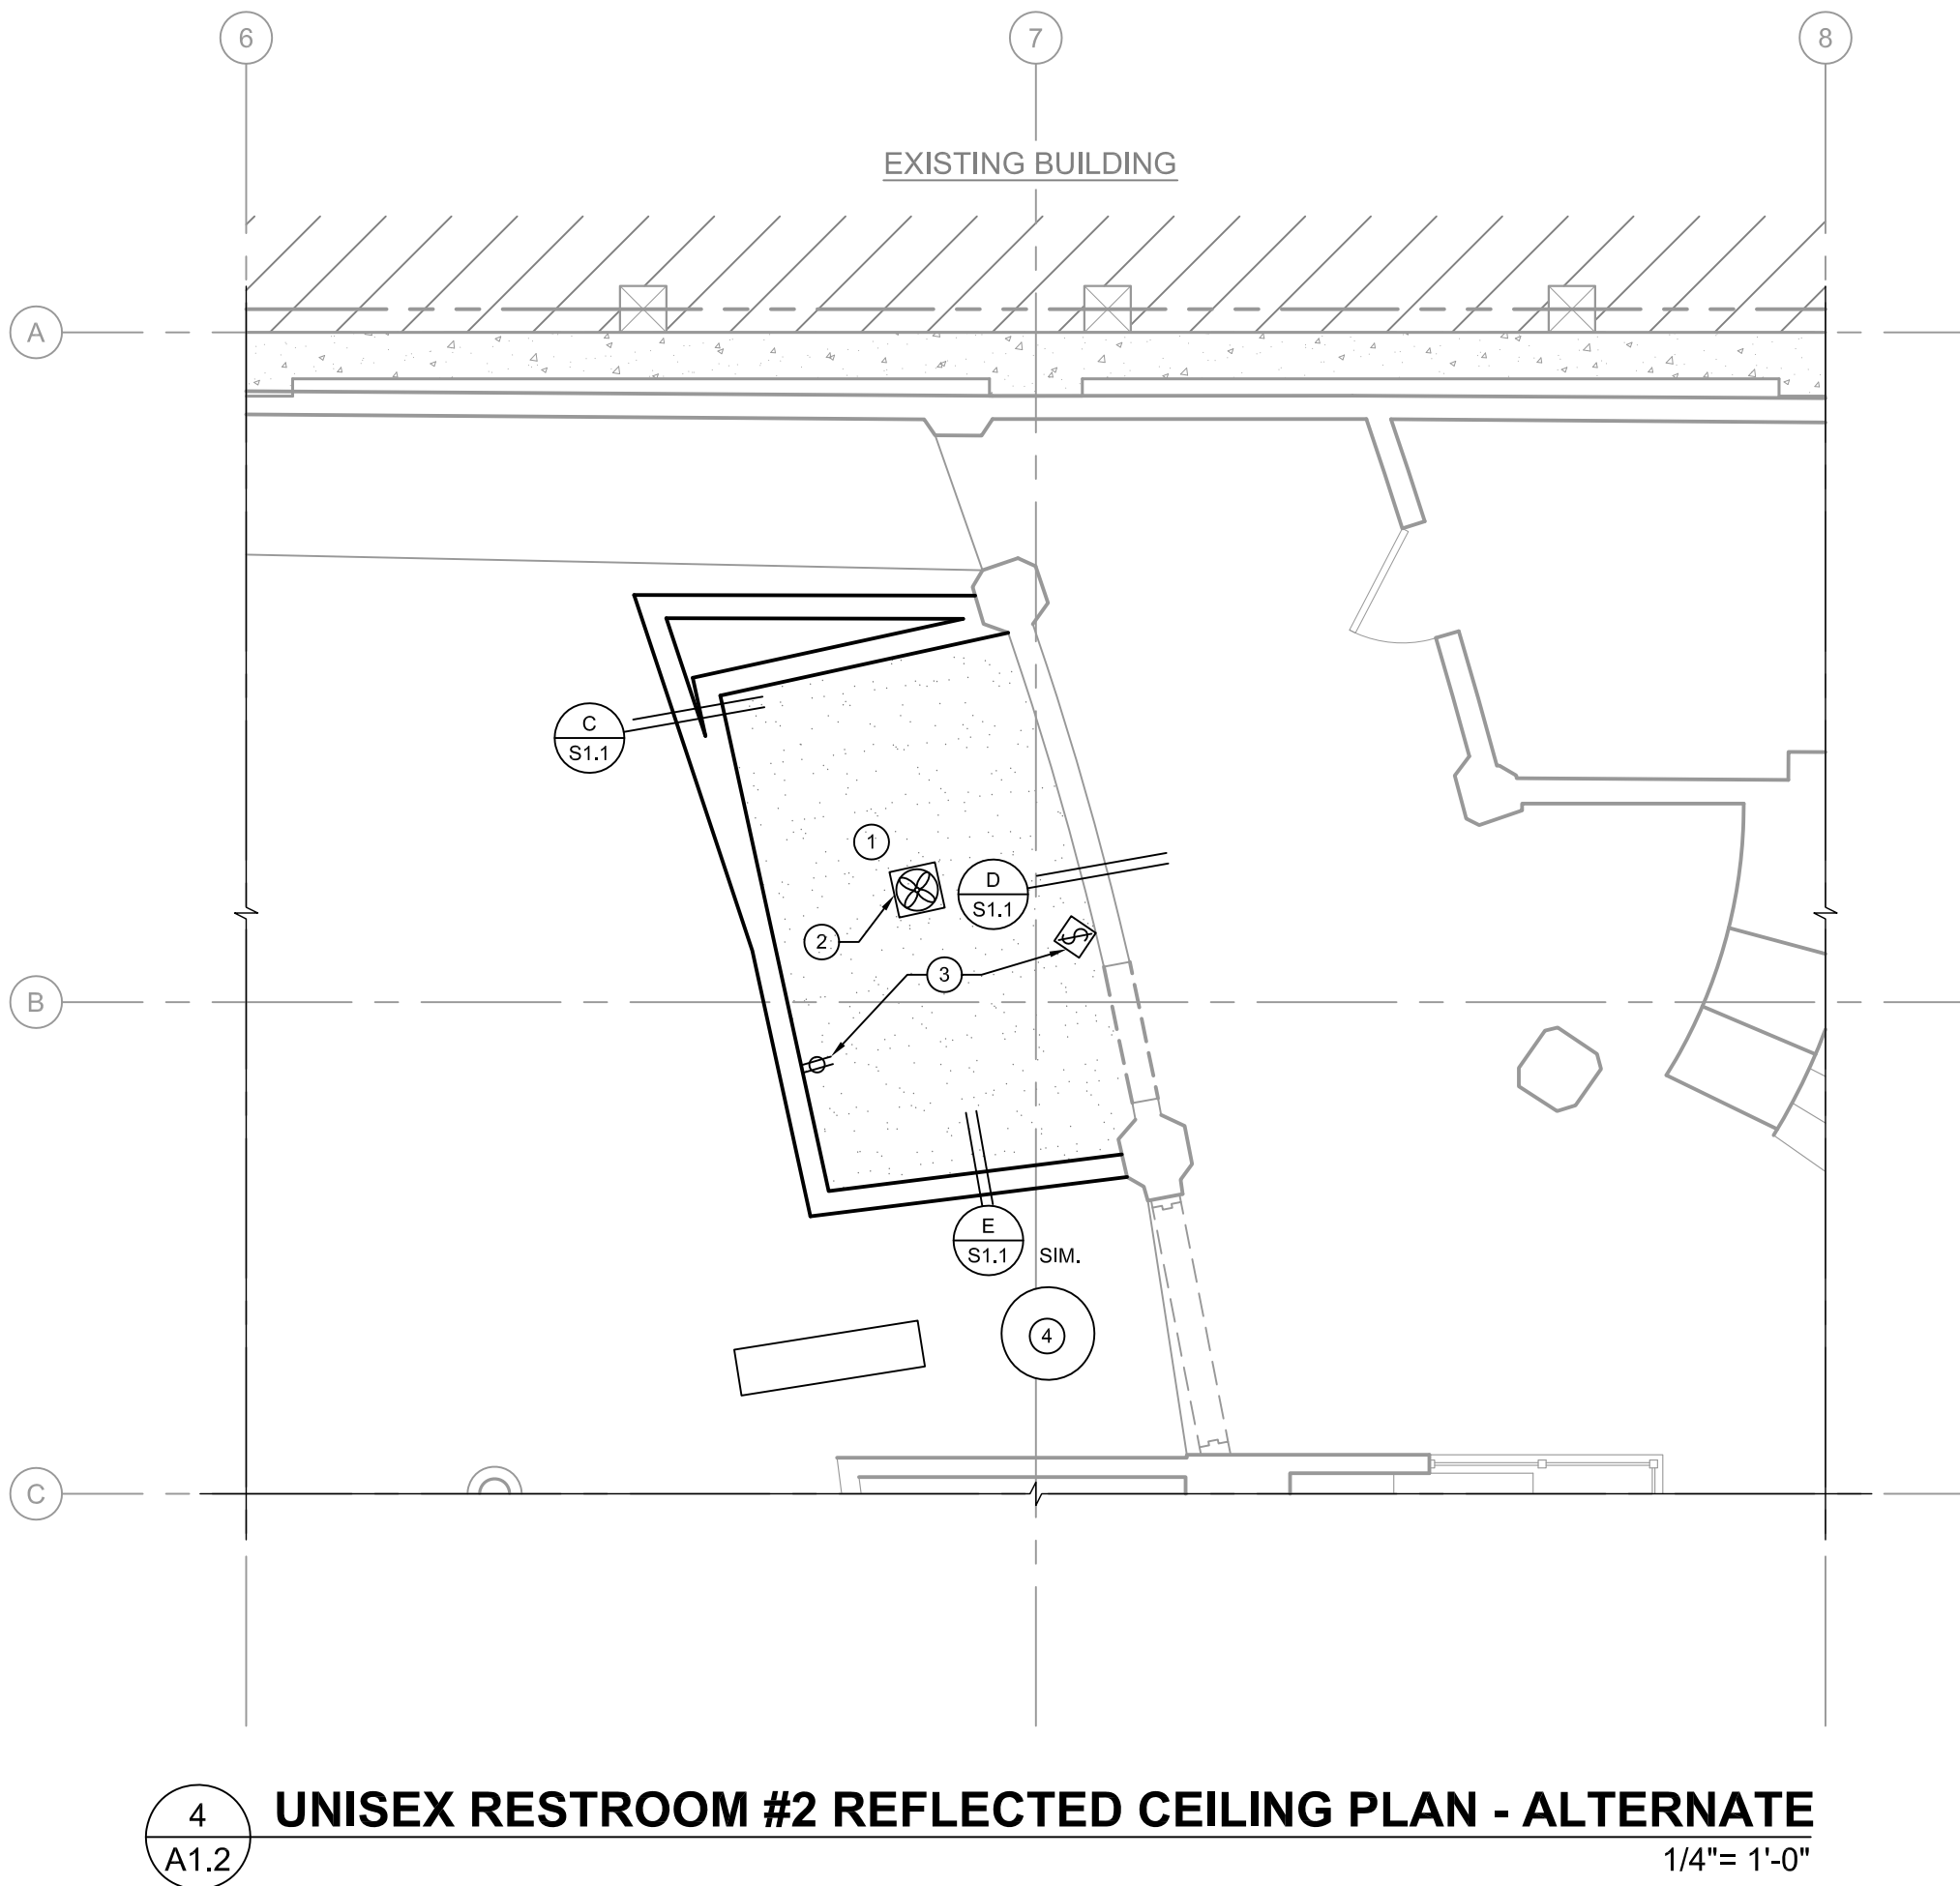


ALTERNATE REFLECTED CEILING PLAN KEYED NOTES

- 1 EXISTING CEILING AND FINISHES TO REMAIN. PLACE SINGLE LAYER OF OWENS-CORNING QUIET-ZONE ACOUSTICAL BATTS OR APPROVED EQUAL ABOVE CEILING. PAINT PER INTERIOR ELEVATIONS.
- 2 NEW EXHAUST FAN PER MECHANICAL DRAWINGS (FIELD PREP AND PAINT GRILLE TO MATCH CEILING COLOR - 1 COAT PRIMER AND 2 COATS SATIN LATEX PAINT). MECHANICAL CONTRACTOR TO UTILIZE (E) RETURN AIR OPENING IN (E) CEILING FOR EXHAUST FAN. COORDINATE WITH MECHANICAL PLANS.
- 3 SWITCHING AND POWER PER ELECTRICAL PLANS. PROVIDE WHITE COLOR AT ALL COVERS AND FIXTURES FOR ELECTRICAL.
- 4 REINSTALL SALVAGED PERIOD LIGHTING FIXTURE AT LOCATION SHOWN (FINALIZE LAYOUT WITH OWNER PRIOR TO CONSTRUCTION)

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EGYPTIAN THEATRE RESTROOMS

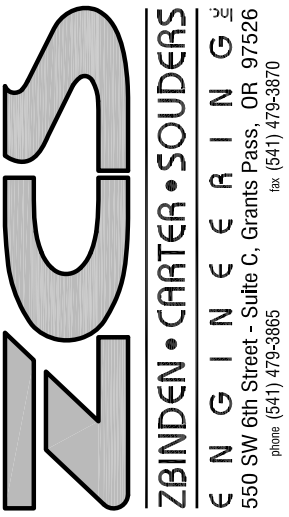


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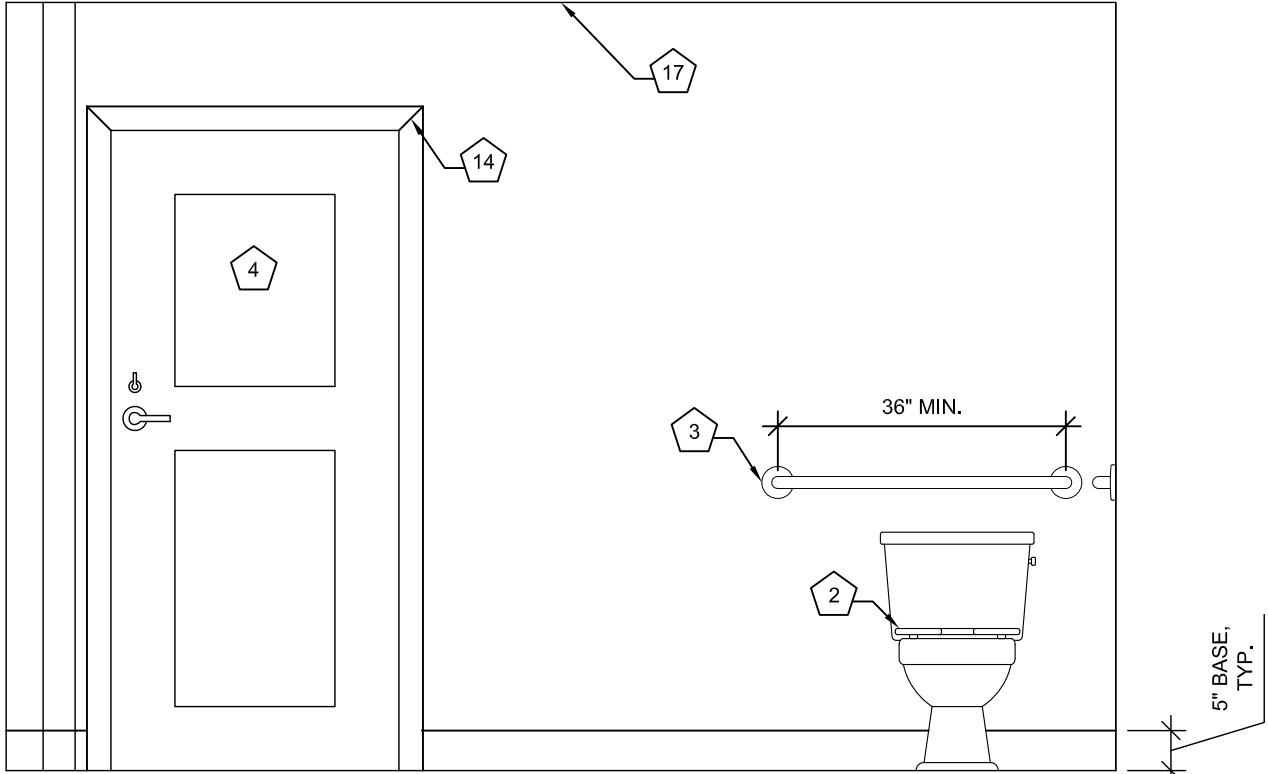


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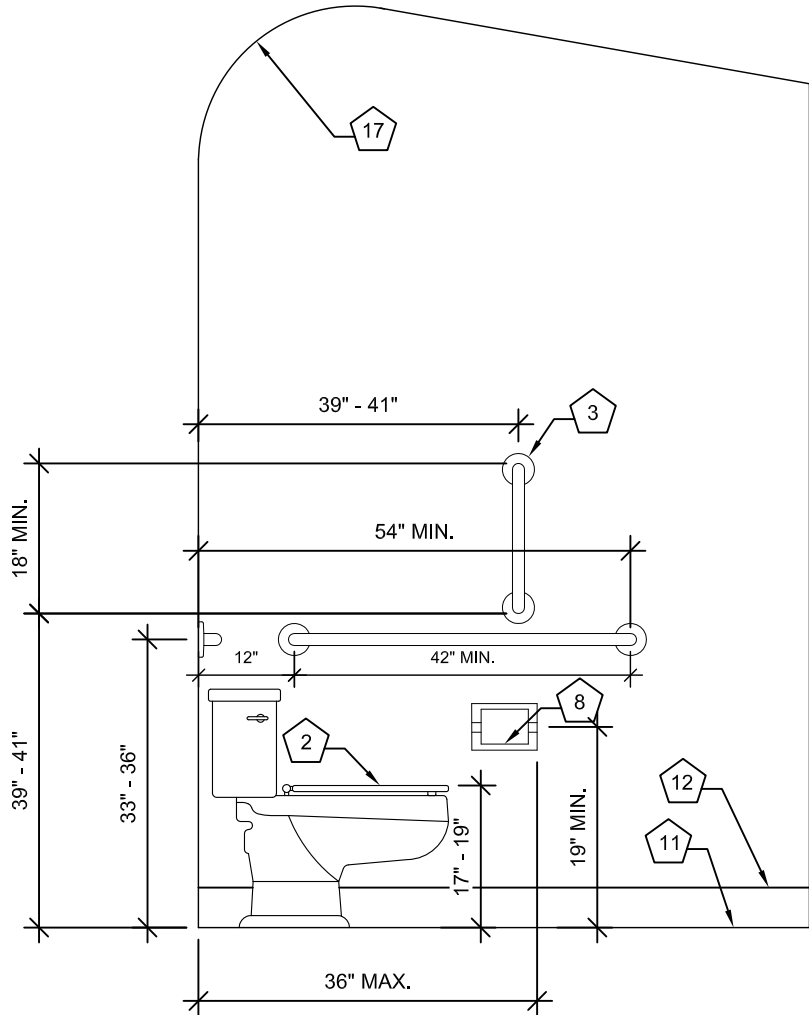
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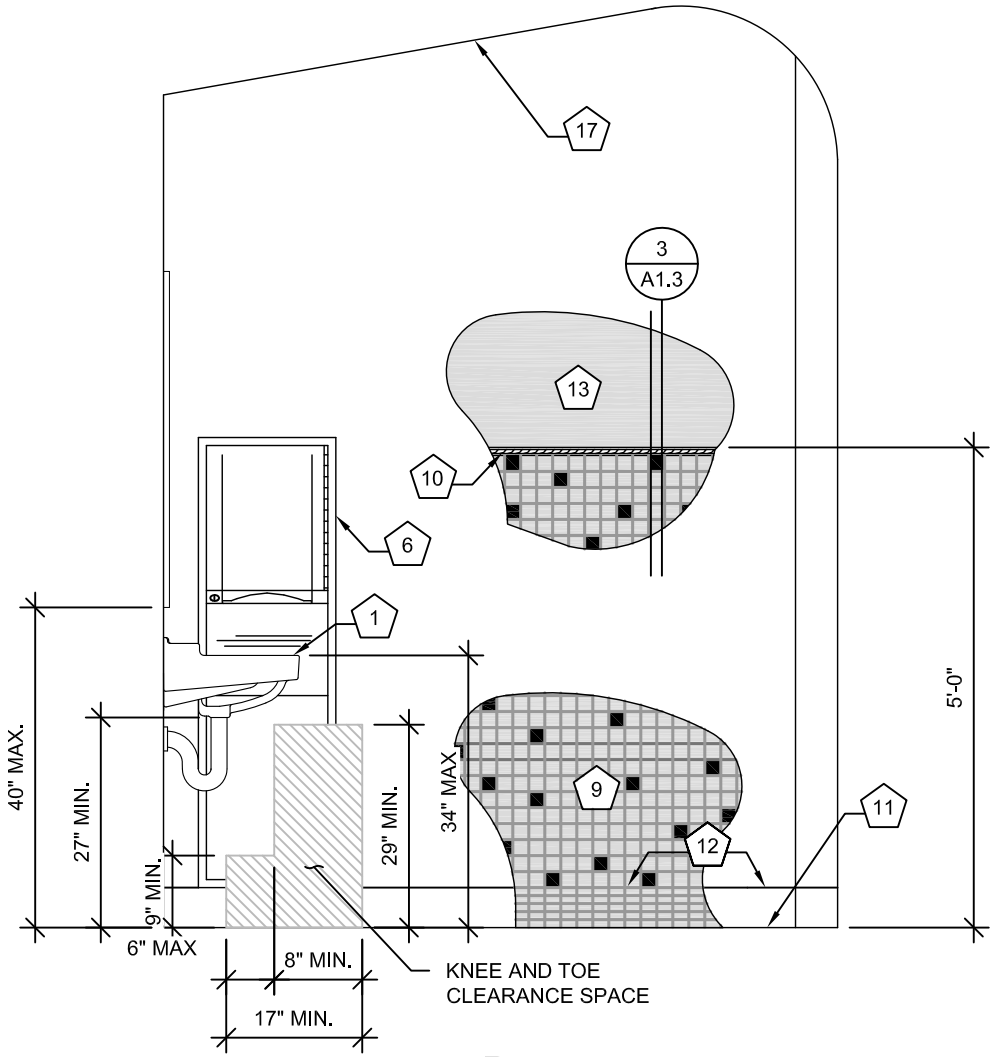
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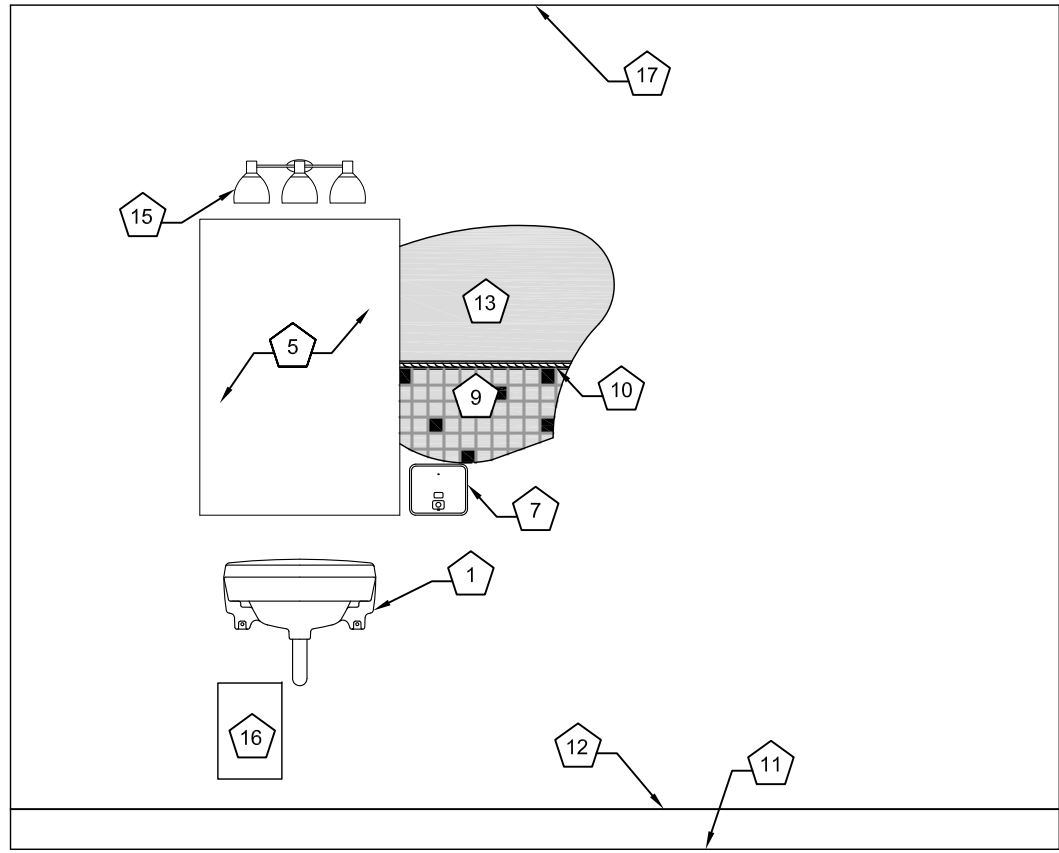


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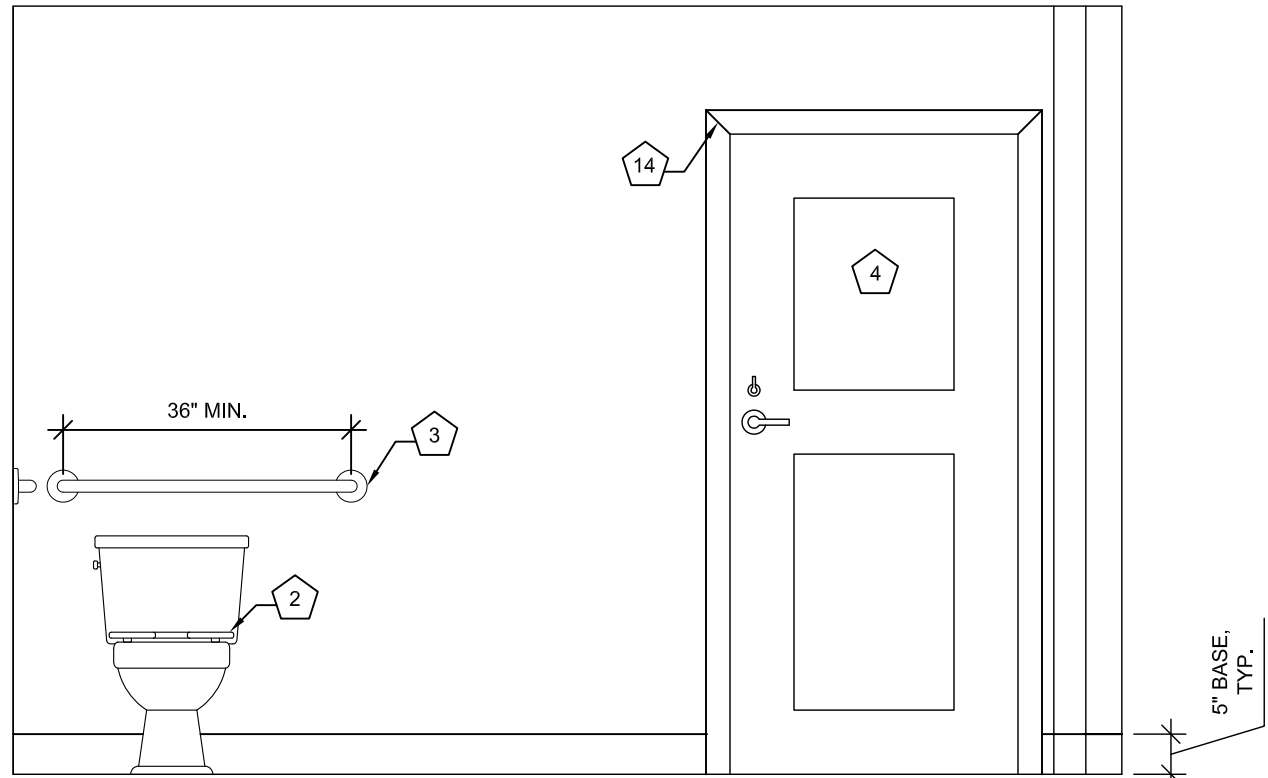


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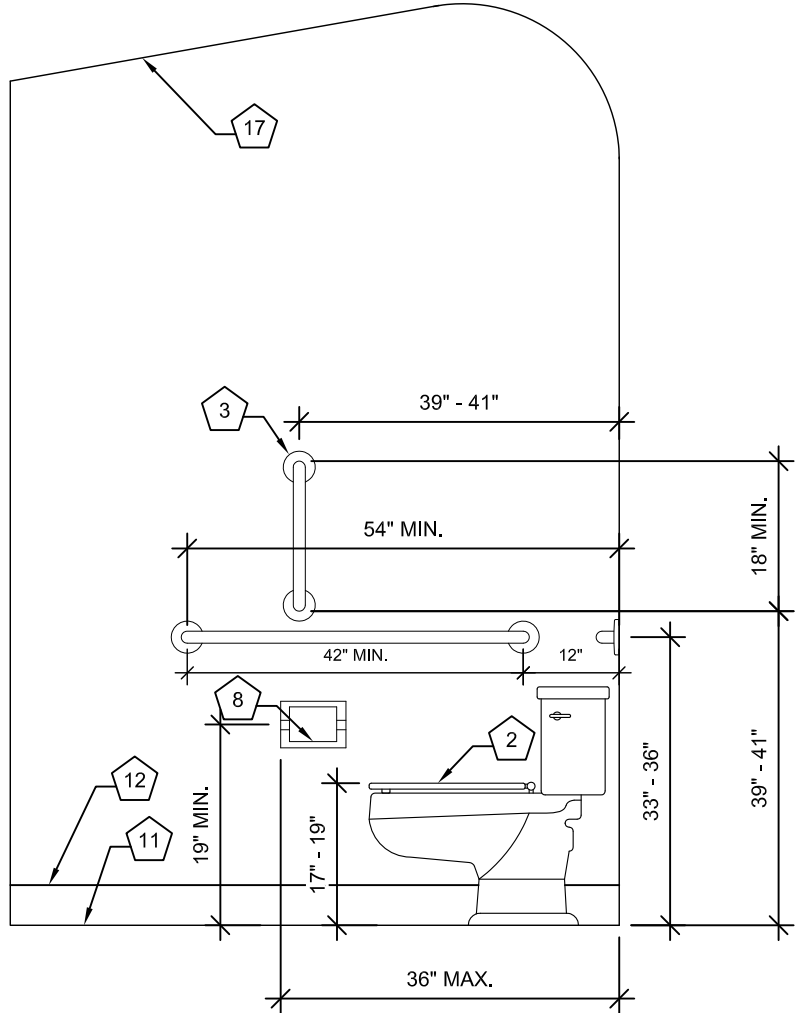
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A1.2 UNISEX BATHROOM #1 INTERIOR ELEVATIONS
1/2"= 1'-0"

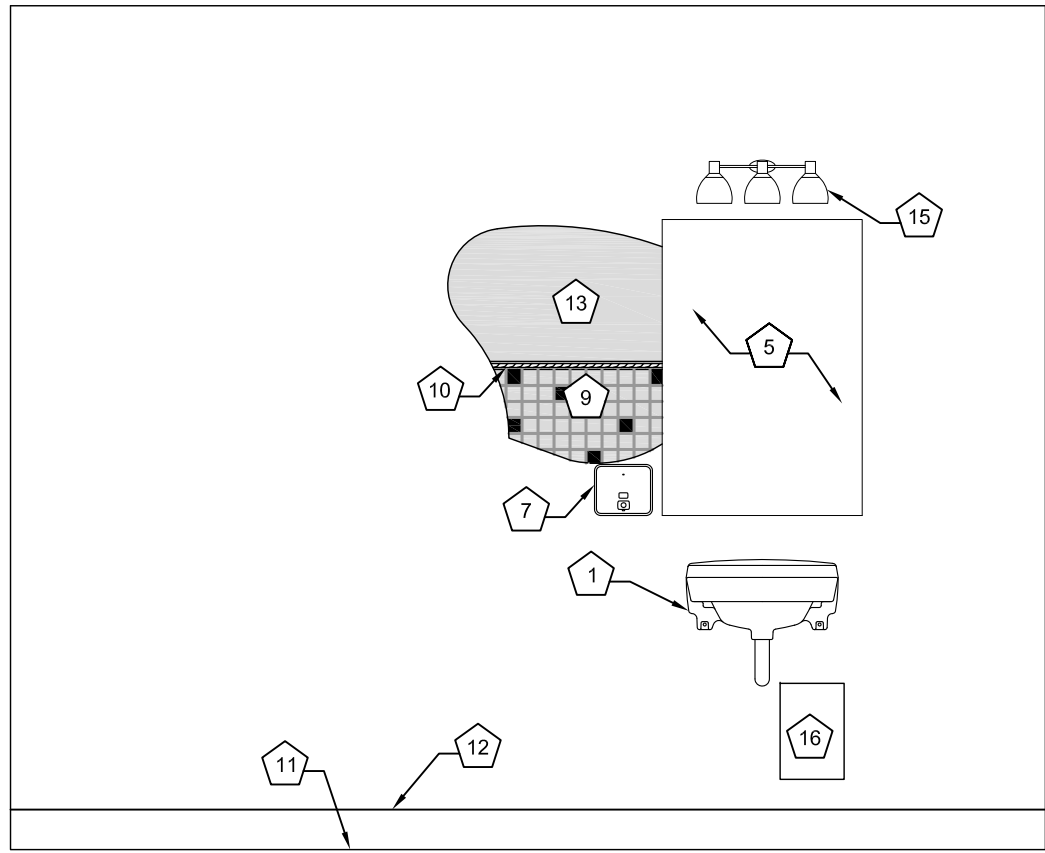


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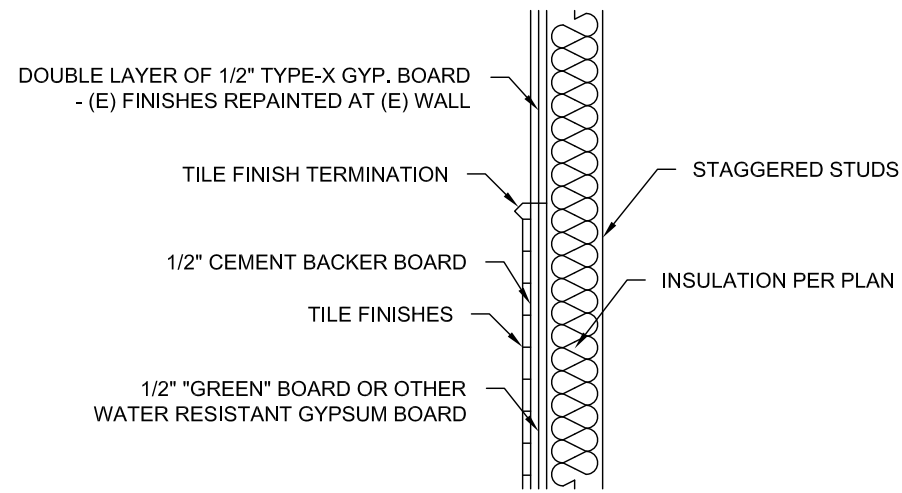


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D

2
A1.2 UNISEX BATHROOM #2 INTERIOR ELEVATION - ALTERNATE
1/2"= 1'-0"



3
A1.2 RESTROOM FINISH DETAIL
1"= 1'-0"

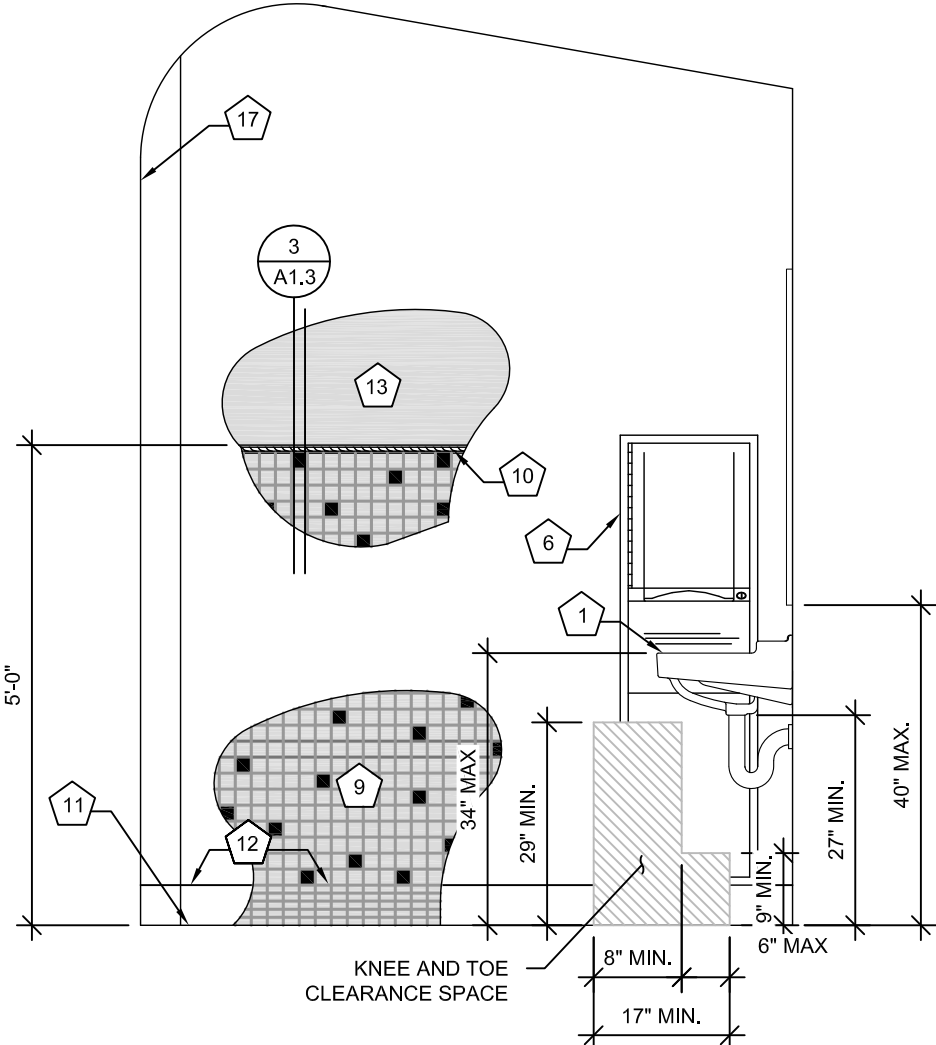
GENERAL INTERIOR ELEVATION NOTES:

- 1 AMERICAN STANDARD WALL-MOUNT LAVATORY PER PLUMBING PLANS (PROVIDE WHITE INSULATED TRAP AND HOT WATER COVERS, TYP.)
- 2 AMERICAN STANDARD TOILET PER PLUMBING PLANS
- 3 BOBRICK OR APPROVED EQUAL 1-1/2" O.D. STAINLESS STEEL GRAB BARS AS SHOWN WITH NON-SLIP SURFACE AND CONCEALED FLANGE MOUNTING
- 4 JELD-WEN MODEL 0028 2-PANEL DOOR OR APPROVED EQUAL SOLID WOOD CORE DOOR - PAINT GOLD TO MATCH OTHER LOBBY DOORS. PROVIDE MINIMUM 20 MINUTE RATED ASSEMBLY. HARDWARE TO BE L-SERIES MORTISE LOCK AS MANUFACTURED BY SCHLAGE LOCKS, WITH LEVER HANDLE AND EZ TURN TOGGLE BOLT WITH BRONZE FINISH TO MATCH (E) HARDWARE. PROVIDE OCCUPANCY INDICATOR. PROVIDE METAL DOOR FRAME (BLACK FACTORY FINISH) WITH METAL CASING ON RESTROOM SIDE (SEE NOTE 14 FOR FINISH) AND METAL CASING (BLACK FACTORY FINISH) ON LOBBY SIDE. LAP CASING OVER FINISHES AT EACH SIDE AND FIELD VERIFY WALL WIDTH FOR FRAME ORDERING. MANUFACTURER TO BE CECO DOORS OR APPROVED EQUAL.
- 5 TEMPERED GLASS FRAME-LESS MIRROR (DELETE TILE AS REQUIRED TO INSTALL MIRRORS AND SET TIGHT INTO TILE CAVITY AT WALL)
- 6 BOBRICK B-3942 SEMI-RECESSED CONVERTIBLE PAPER TOWEL DISPENSER/WASTE RECEPTACLE OR APPROVED EQUAL. INSTALL PER MANUFACTURER'S SPECIFICATIONS. (MUST MEET ALL ADA REQUIREMENTS)
- 7 BOBRICK B-4063 STAINLESS STEEL RECESSED SOAP DISPENSER OR APPROVED EQUAL (PLACEMENT PER ADA STANDARDS)
- 8 BOBRICK B-663 STAINLESS STEEL RECESSED TOILET TISSUE DISPENSER OR APPROVED EQUAL
- 9 TILE WAINSCOT WALL FINISH - FIELD TILE IS AMERICAN OLEAN UNGLAZED CERAMIC MOSAICS 2"x2" (CAPPUCCINO A78) ACCENT TILE IS DAL-TILE GLAZED 2"x2" (BLACK 6421). PLACE 75% FIELD, 25% ACCENT, (TYP.) - RANDOM PATTERN
- 10 TRIM TILE FINISH - DAL-TILE 1"x6" ROPE LINER (BLACK GLOSS) (TYP.)
- 11 TILE FLOOR FINISH - AMERICAN OLEAN UNGLAZED CERAMIC MOSAICS 2"x2" (CAPPUCCINO A78) (TYP.)
- 12 TILE COVE/TRANSITION - AMERICAN OLEAN UNGLAZED CERAMIC MOSAICS 2"x1" (CAPPUCCINO A78) (TYP.)
- 13 TEXTURED AND PAINTED WALL AND CEILING FINISH - SKIM COAT TO MATCH (E) CEILING AT (N) WALLS (SUBMIT TEXTURE MOCK-UP PRIOR TO CONSTRUCTION FOR APPROVAL). PAINT 1 COAT PRIMER AND 2 FINISH COATS OF SATIN LATEX KELLY MOORE (SPANISH SAND 231) OR APPROVED EQUAL. (TYP.)
- 14 PAINTED CASING FINISH - 1COAT PRIMER SUITABLE FOR METAL SUBSTRATE AND 2 FINISH COATS OF SEMI-GLOSS LATEX KELLY MOORE (SPANISH SAND) OR APPROVED EQUAL. (TYP.) (G.C. TO PREP METAL FOR RE-FINISH IN FIELD)
- 15 LIGHT FIXTURE PER ELECTRICAL PLANS (OIL-RUBBED BRONZE FINISH)
- 16 POINT OF USE WATER HEATER - SEE PLUMBING PLANS.
- 17 PAINT ALL (E) FINISHES TO REMAIN (CEILING AND TRANSITION AND (E) WALL ABOVE TILE) TO MATCH NEW WALL FINISHES ABOVE TILE.

NOTE: ALL SHEET METAL VISIBLE THROUGH SUPPLY AND EXHAUST GRILLS TO BE PAINTED FLAT BLACK

NOTE: TILE BOND COAT TO BE LATIGRETE 4237. PROVIDE 1/2" THICK CEMENT BACKER BOARD AT WAINSCOT. PROVIDE REINFORCED CRACK ISOLATION TAPE TO SPAN CONSTRUCTION JOINTS AND OTHER CRACKS AT CONCRETE SLABS. PROVIDE MATTE GROUT SEALER AS RECOMMENDED BY MAN. WITH POLYMER MODIFIED GROUT

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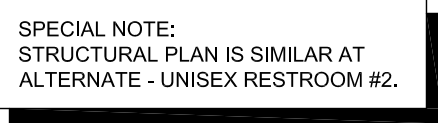
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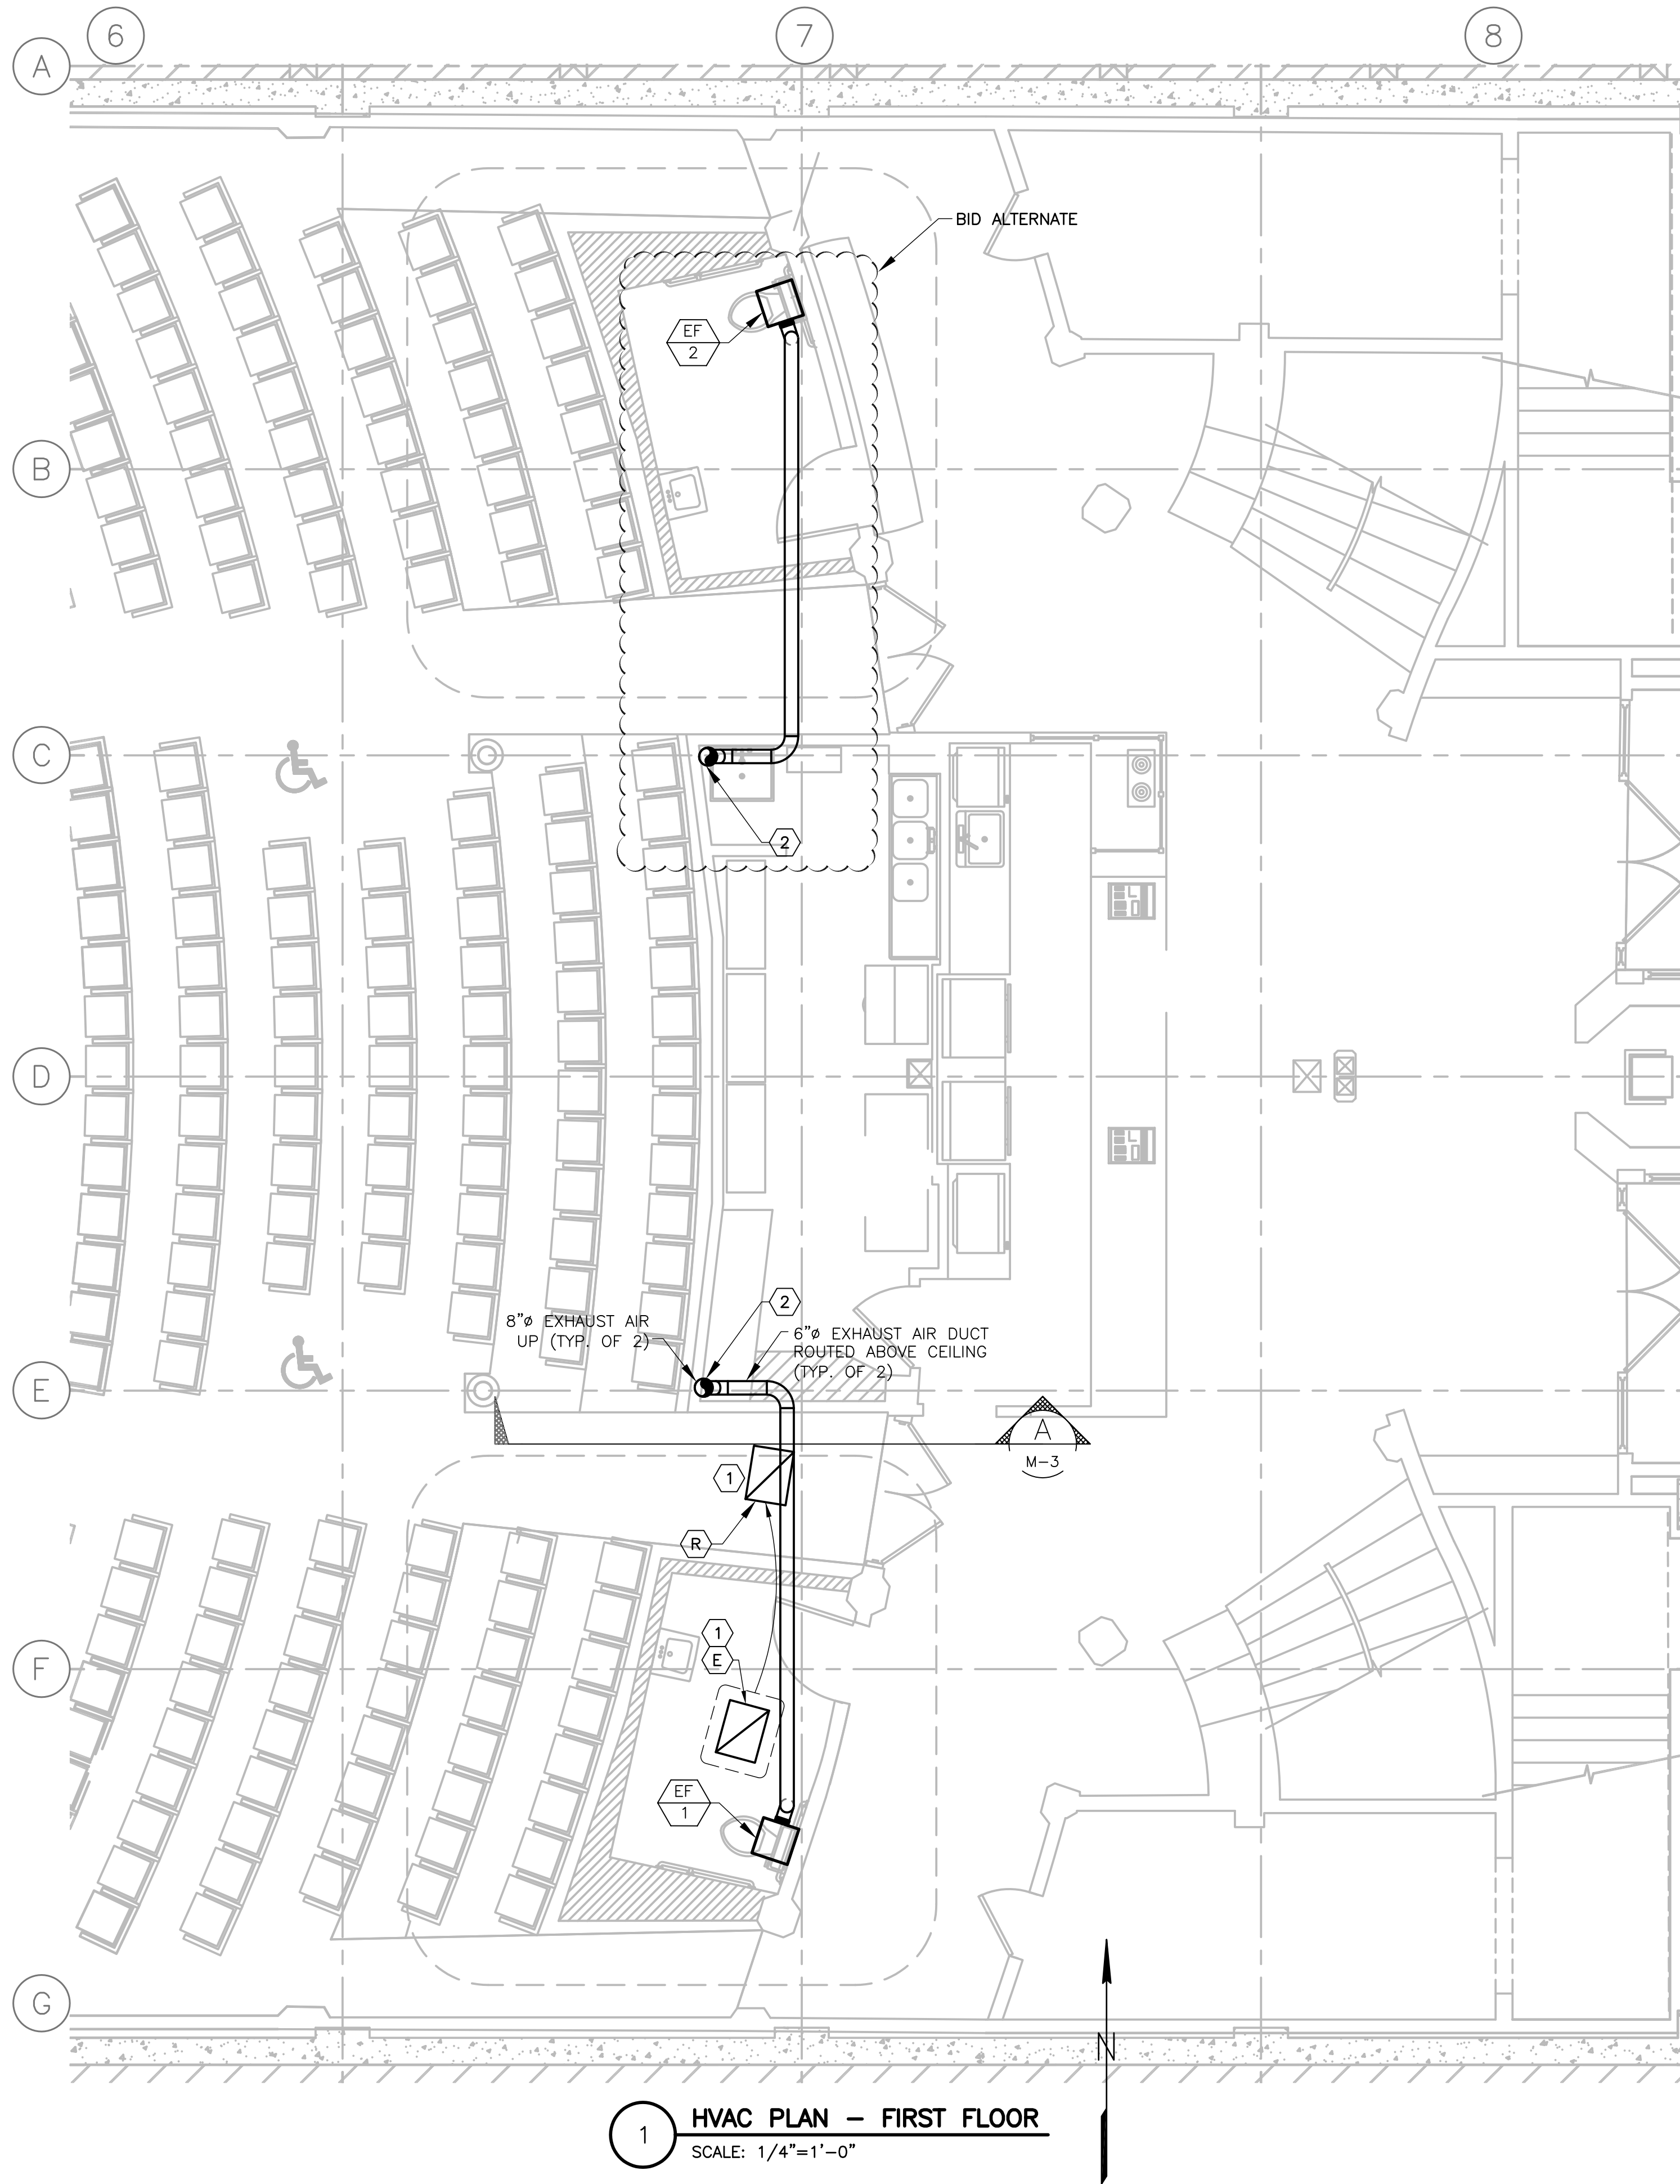
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INTERIOR ELEVATIONS

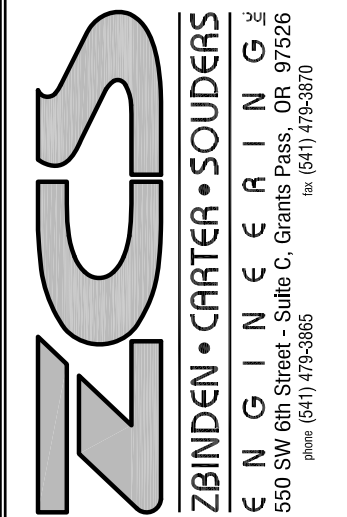A1.3



S1.1



GENERAL NOTES

KEYED NOTES

1 RELOCATE EXISTING 18x24 (APPROX.) RETURN AIR GRILLE AND RETURN AIR DUCT ABOVE CEILING TO CORRIDOR AS SHOWN.

2 FOR CONTINUATION SEE 1
M-3

FAN SCHEDULE

TAG	SERVICE	TYPE	CFM	ESP	ELECTRICAL			MANUFACTURER	MODEL	NOTES
					VOLTS	PHASE	WATTS			
EF-1	WOMEN'S RR	CEILING	72	0.875"	115	1	80	GREENHECK	SP-B110	1-5
EF-2	MENS RR	CEILING	72	0.875"	115	1	80	GREENHECK	SP-B110	1-5

NOTES:


- PROVIDE WITH UNIT MOUNTED SOLID STATE SPEED CONTROL FOR AIR BALANCING.
- CONTROL ON-OFF OPERATION WITH LIGHT SWITCH
- PROVIDE WITH ROOF CAP - SEE ROOF HOOD SCHEDULE
- PROVIDE WITH ALUMINUM BACKDRAFT DAMPER
- GALVANIZED METAL DUCT FROM FAN UP TO ROOF CAP. INSULATE DUCT WITH 1" FIBERGLASS WRAP.

ROOF HOOD SCHEDULE


TAG	AIR DIRECTION	CFM	MAX PRESSURE DROP, "W.G.	THROAT DIMENSIONS	HOOD DIMENSIONS	HEIGHT	MANUFACTURER	MODEL NUMBER	WEIGHT	NOTES
RH-1	EXHAUST	144	0.05	6"x9"	18 3/4"x14 1/4"	6 1/2"	GREENHECK	RJ-6x9	10	1
RH-2	EXHAUST	144	0.05	6"x9"	18 3/4"x14 1/4"	6 1/2"	GREENHECK	RJ-6x9	10	1

NOTE:

- ANCHOR HOOD TO 12" HIGH ROOF CURB.

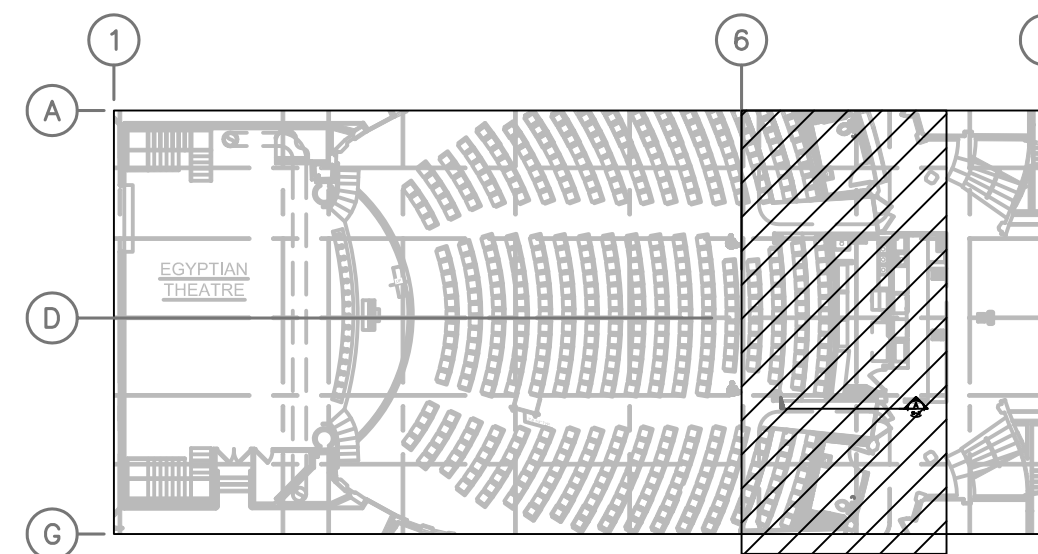

WORK AREA

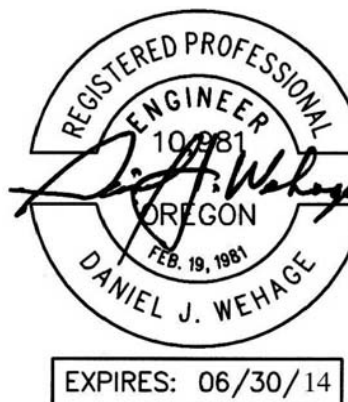

NOTES:

- SEE LEGEND AND GENERAL NOTES ON SHEET M-1.


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BAR EQUALS ONE INCH WHEN DRAWING IS PLOTTED FULL SIZE. IF NOT, SCALE ACCORDINGLY



CITY OF COOS BAY

EGYPTIAN THEATRE RESTROOMS



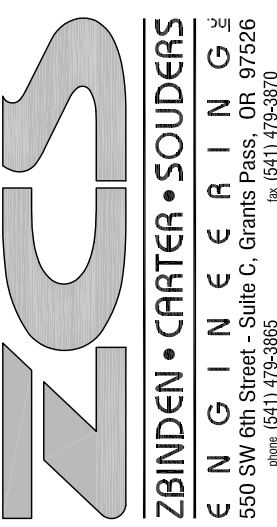


PROJECT NO: 1325
DRAWN: JJ 1325-M-2.dwg
CHECKED: D. WEHAGE
DATE: 7-2-2013

HVAC PLAN
& EQUIPMENT
SCHEDULES


M-2

NO. 1
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DATE
7/1/13
EP

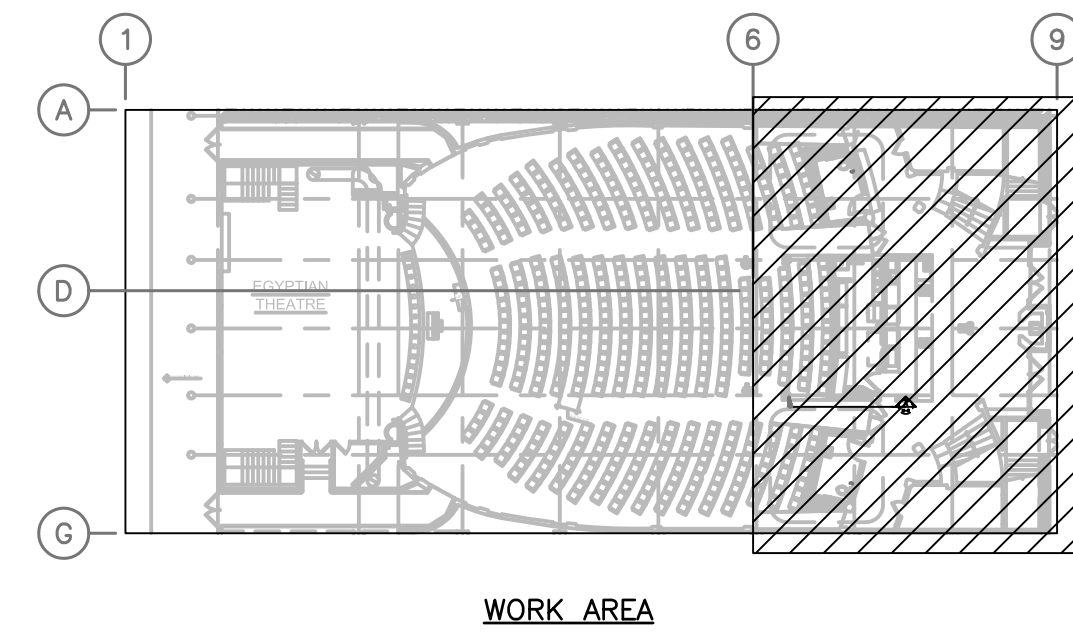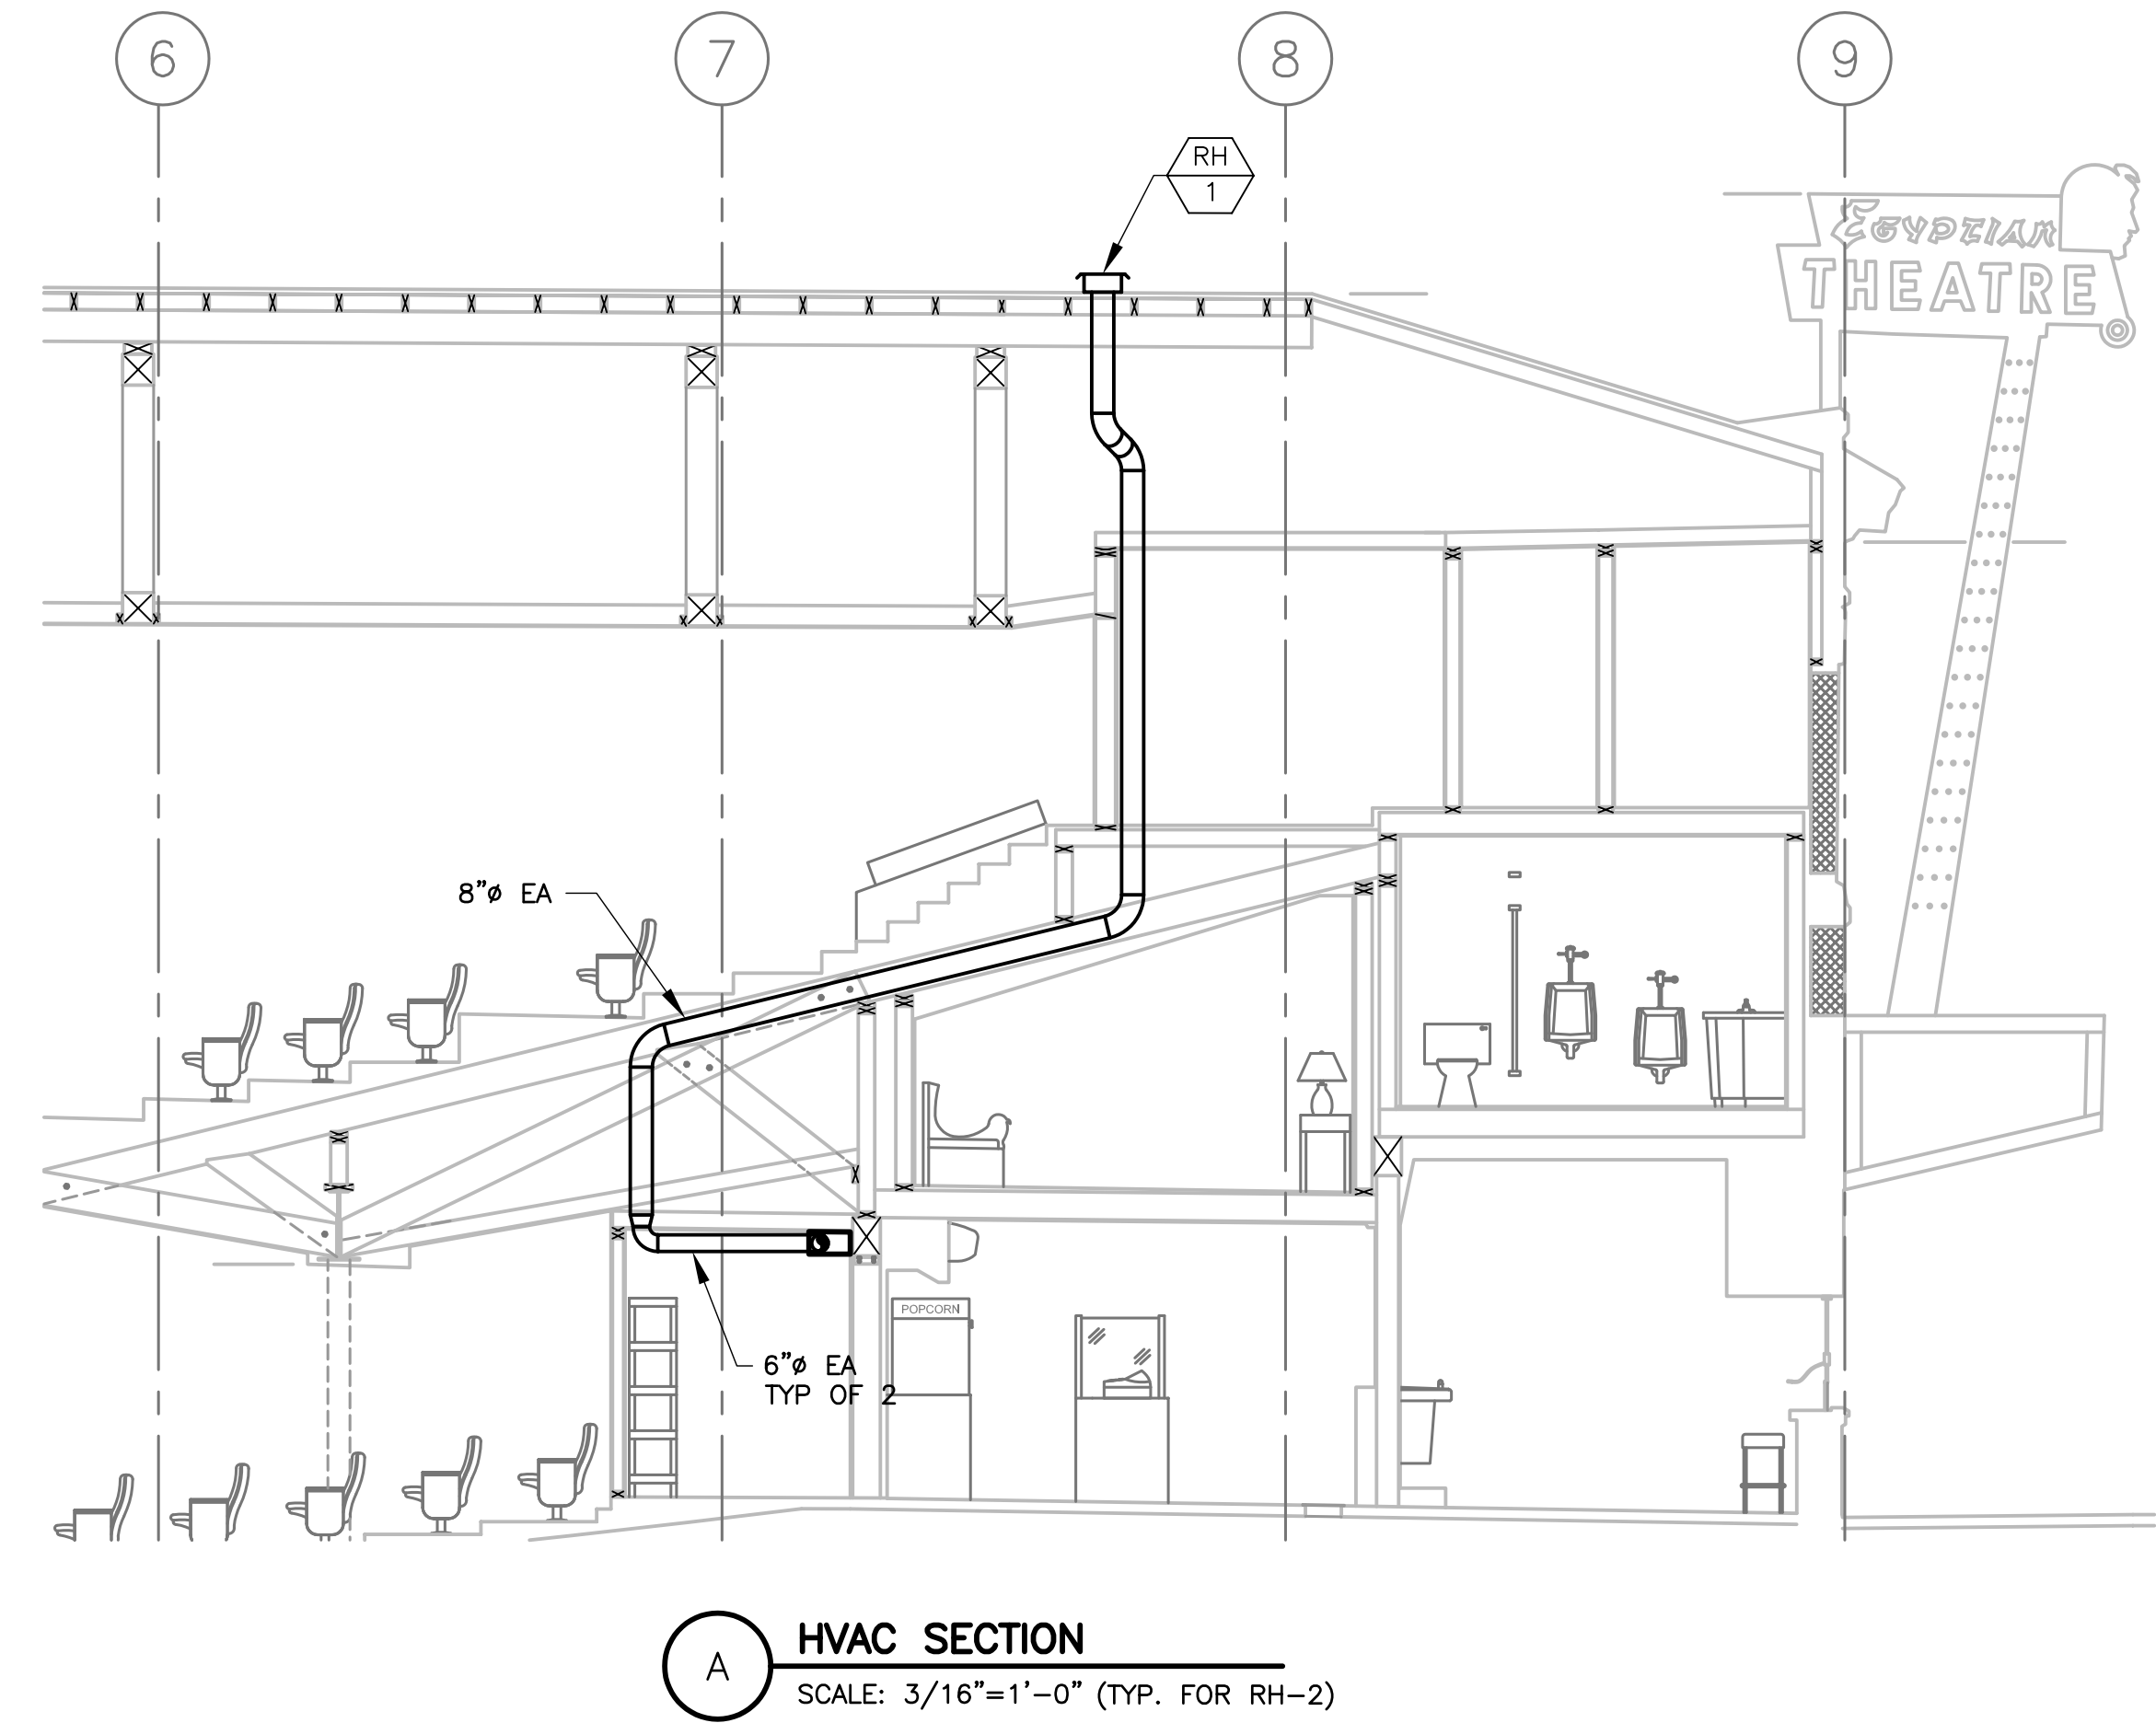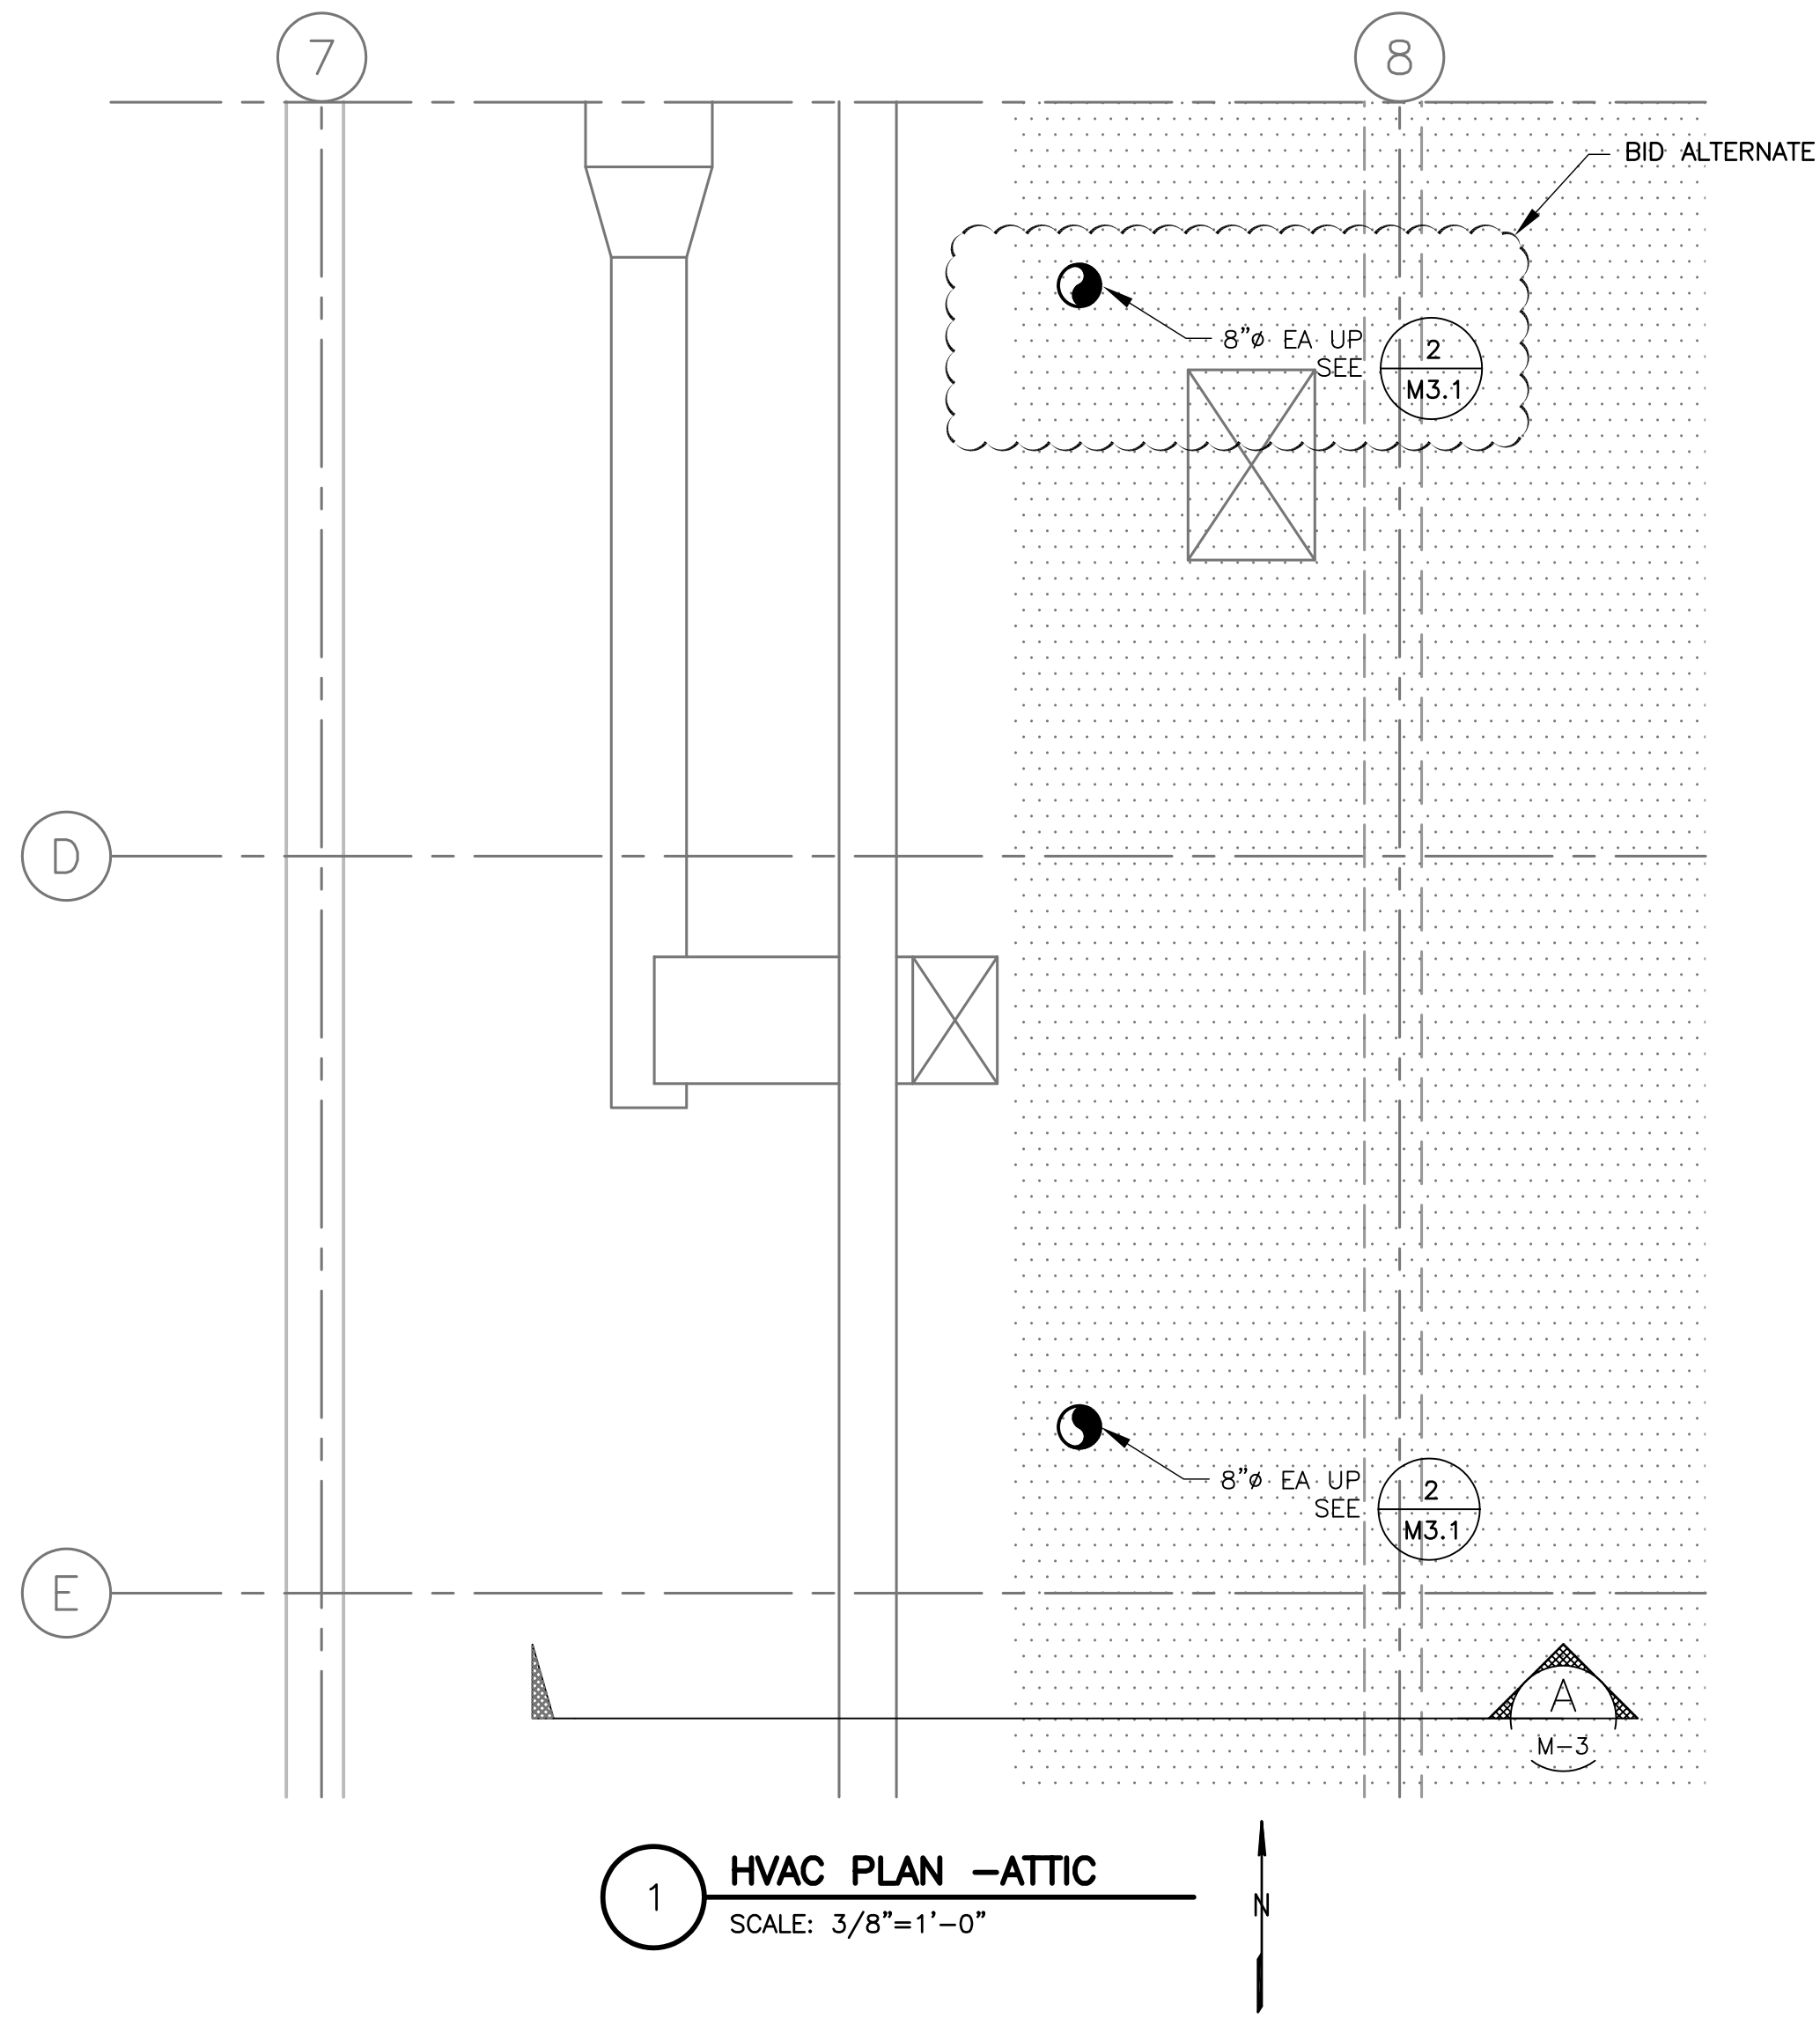


NOTES:
1. SEE LEGEND AND GENERAL NOTES ON SHEET M-1.

1 INCH
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CITY OF COOS BAY
EGYPTIAN THEATRE RESTROOMS

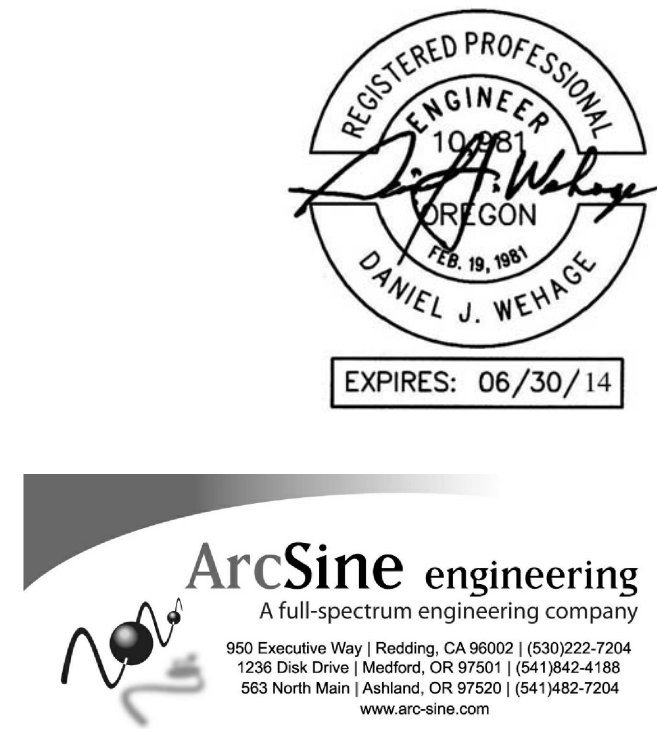
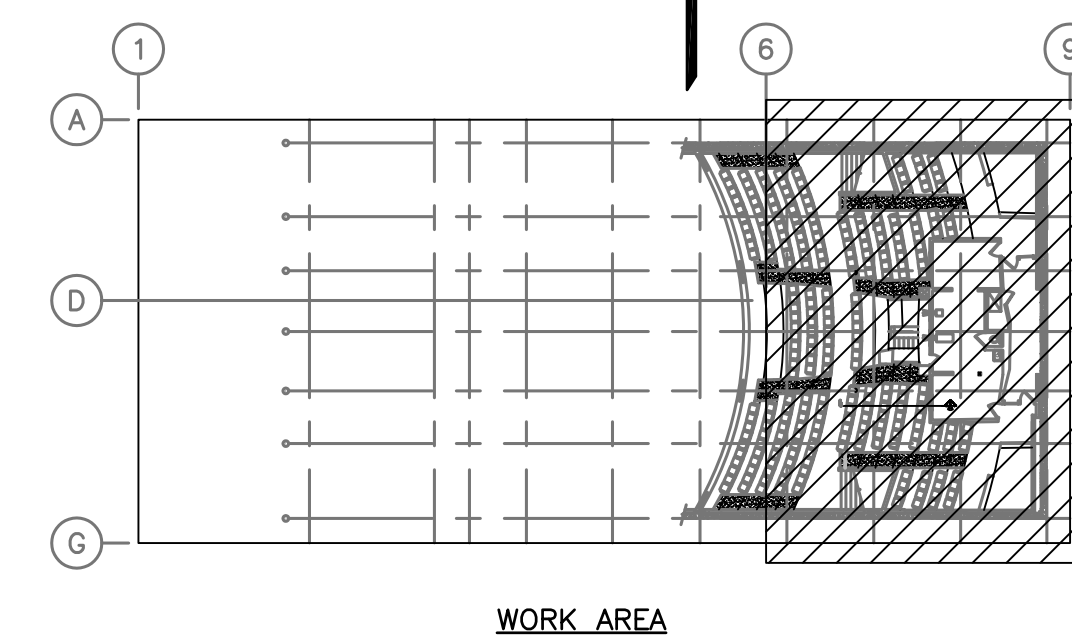
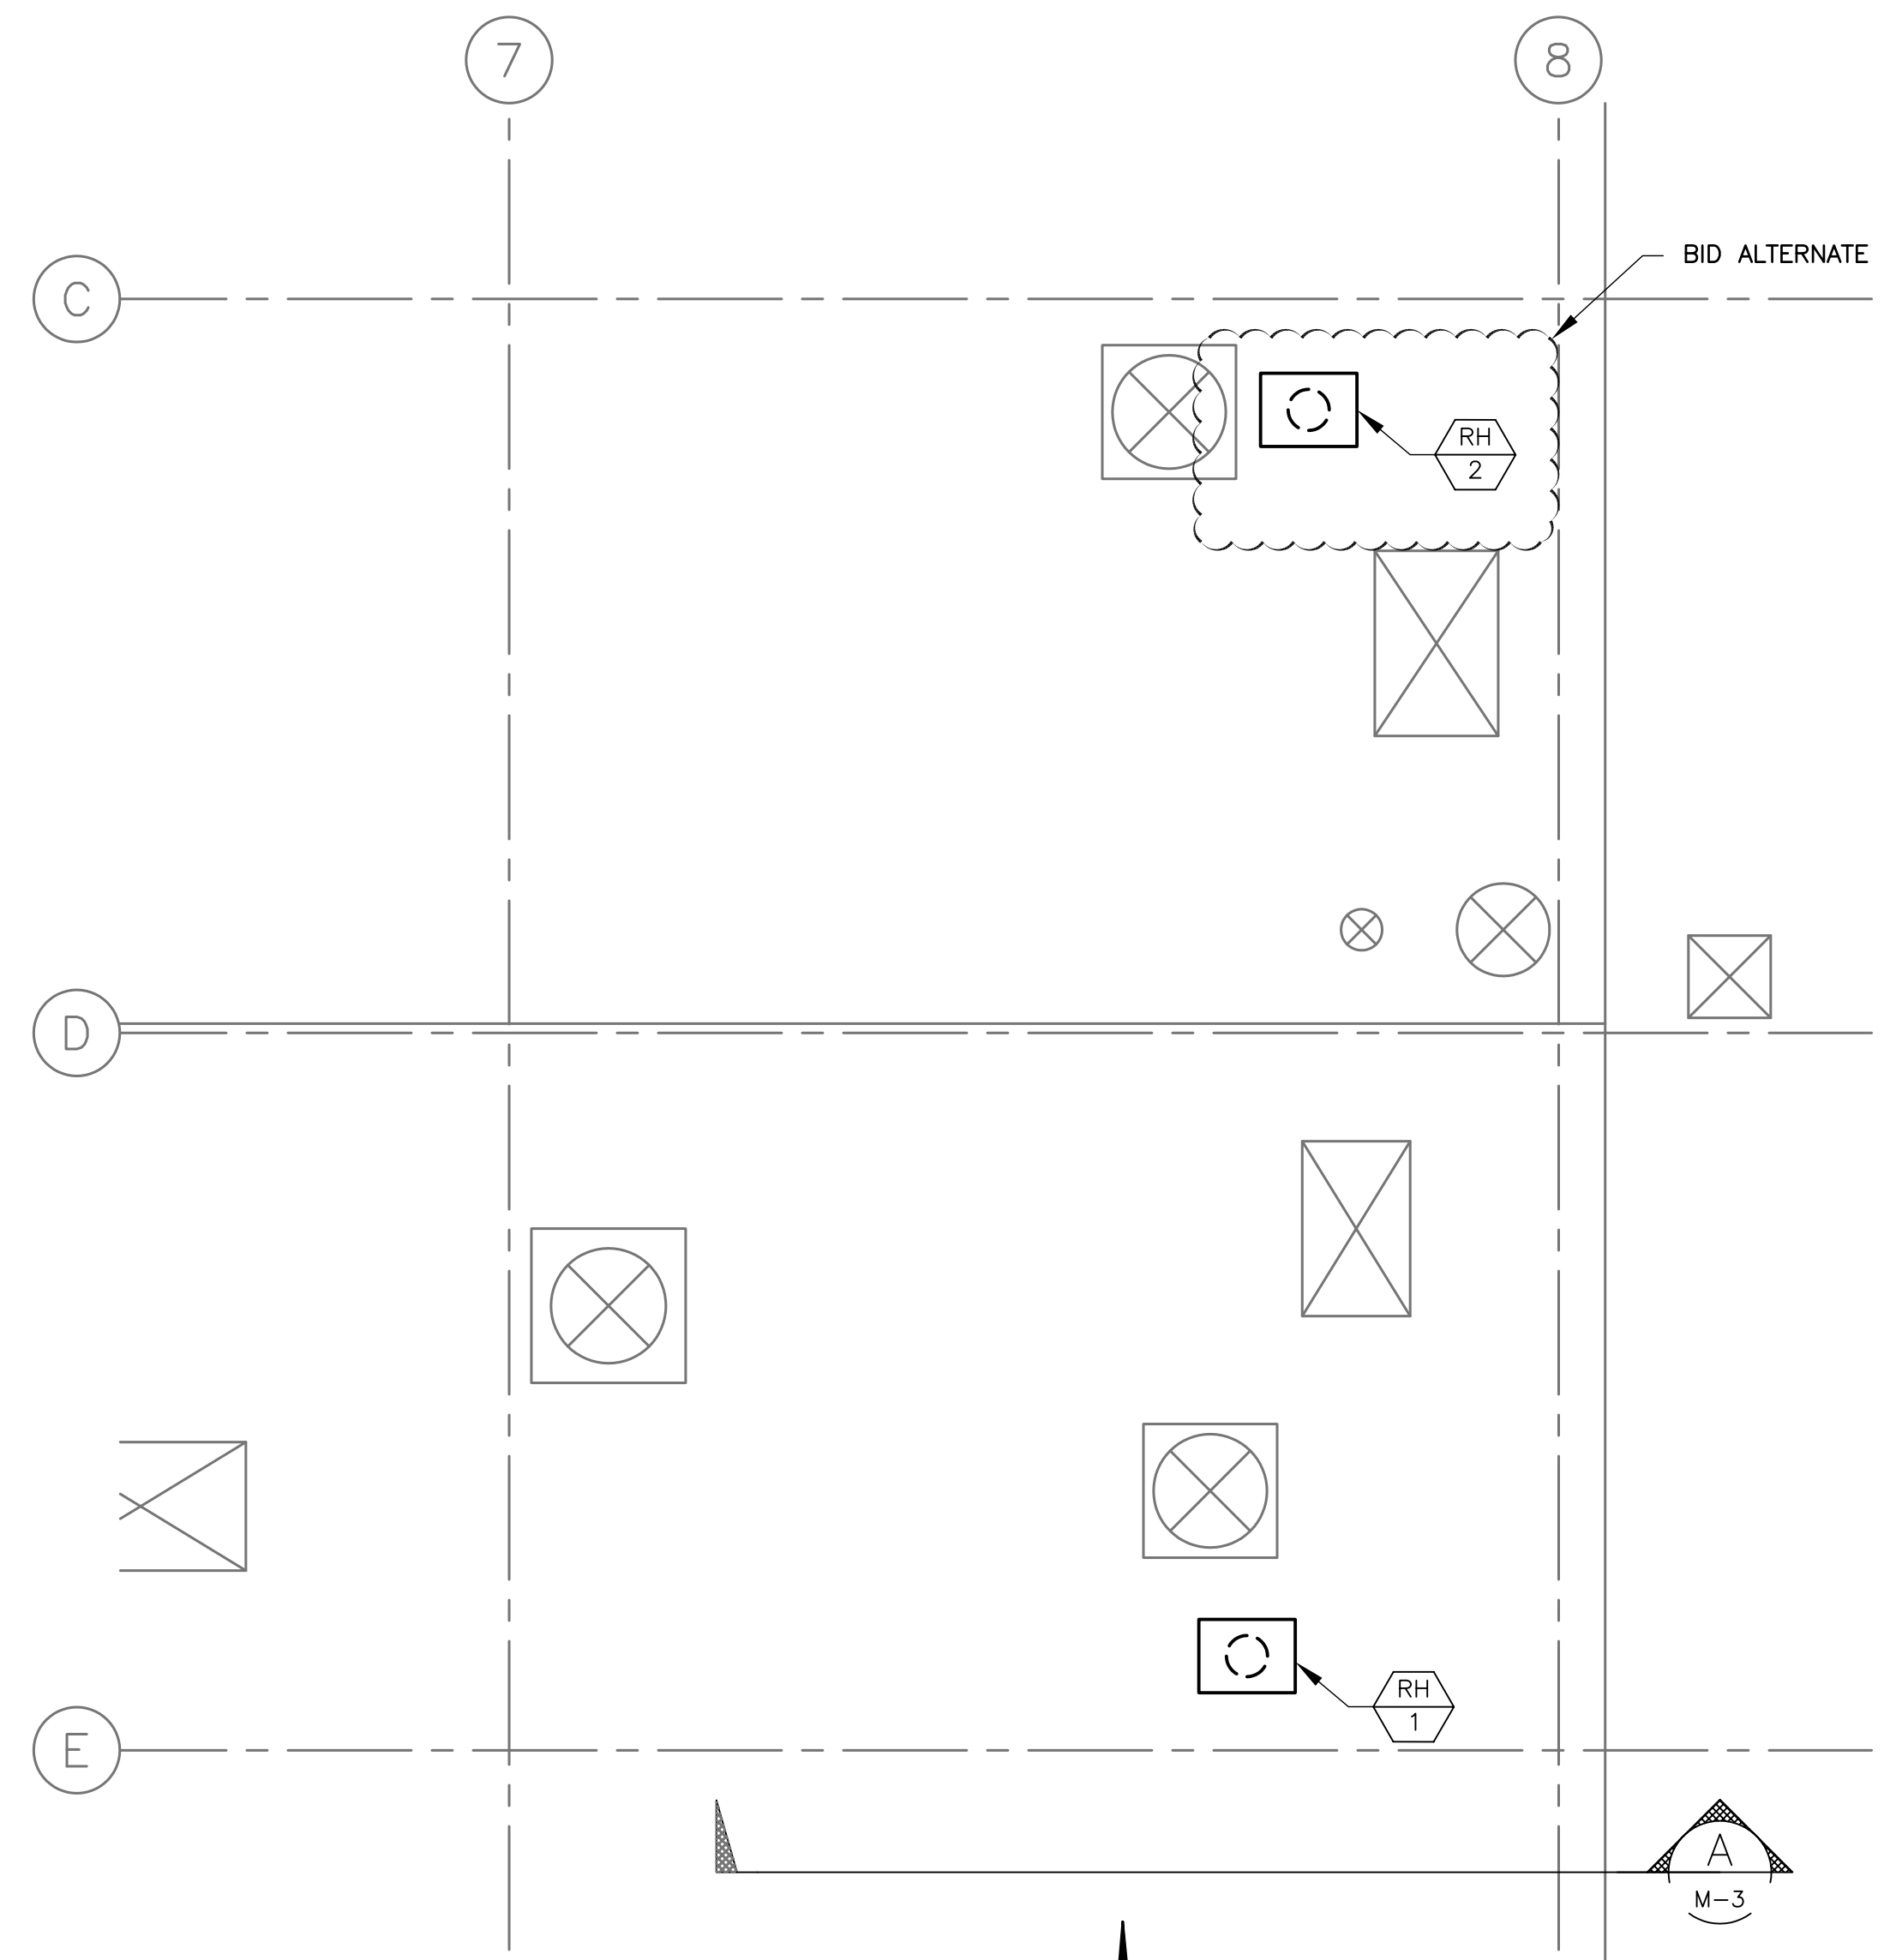
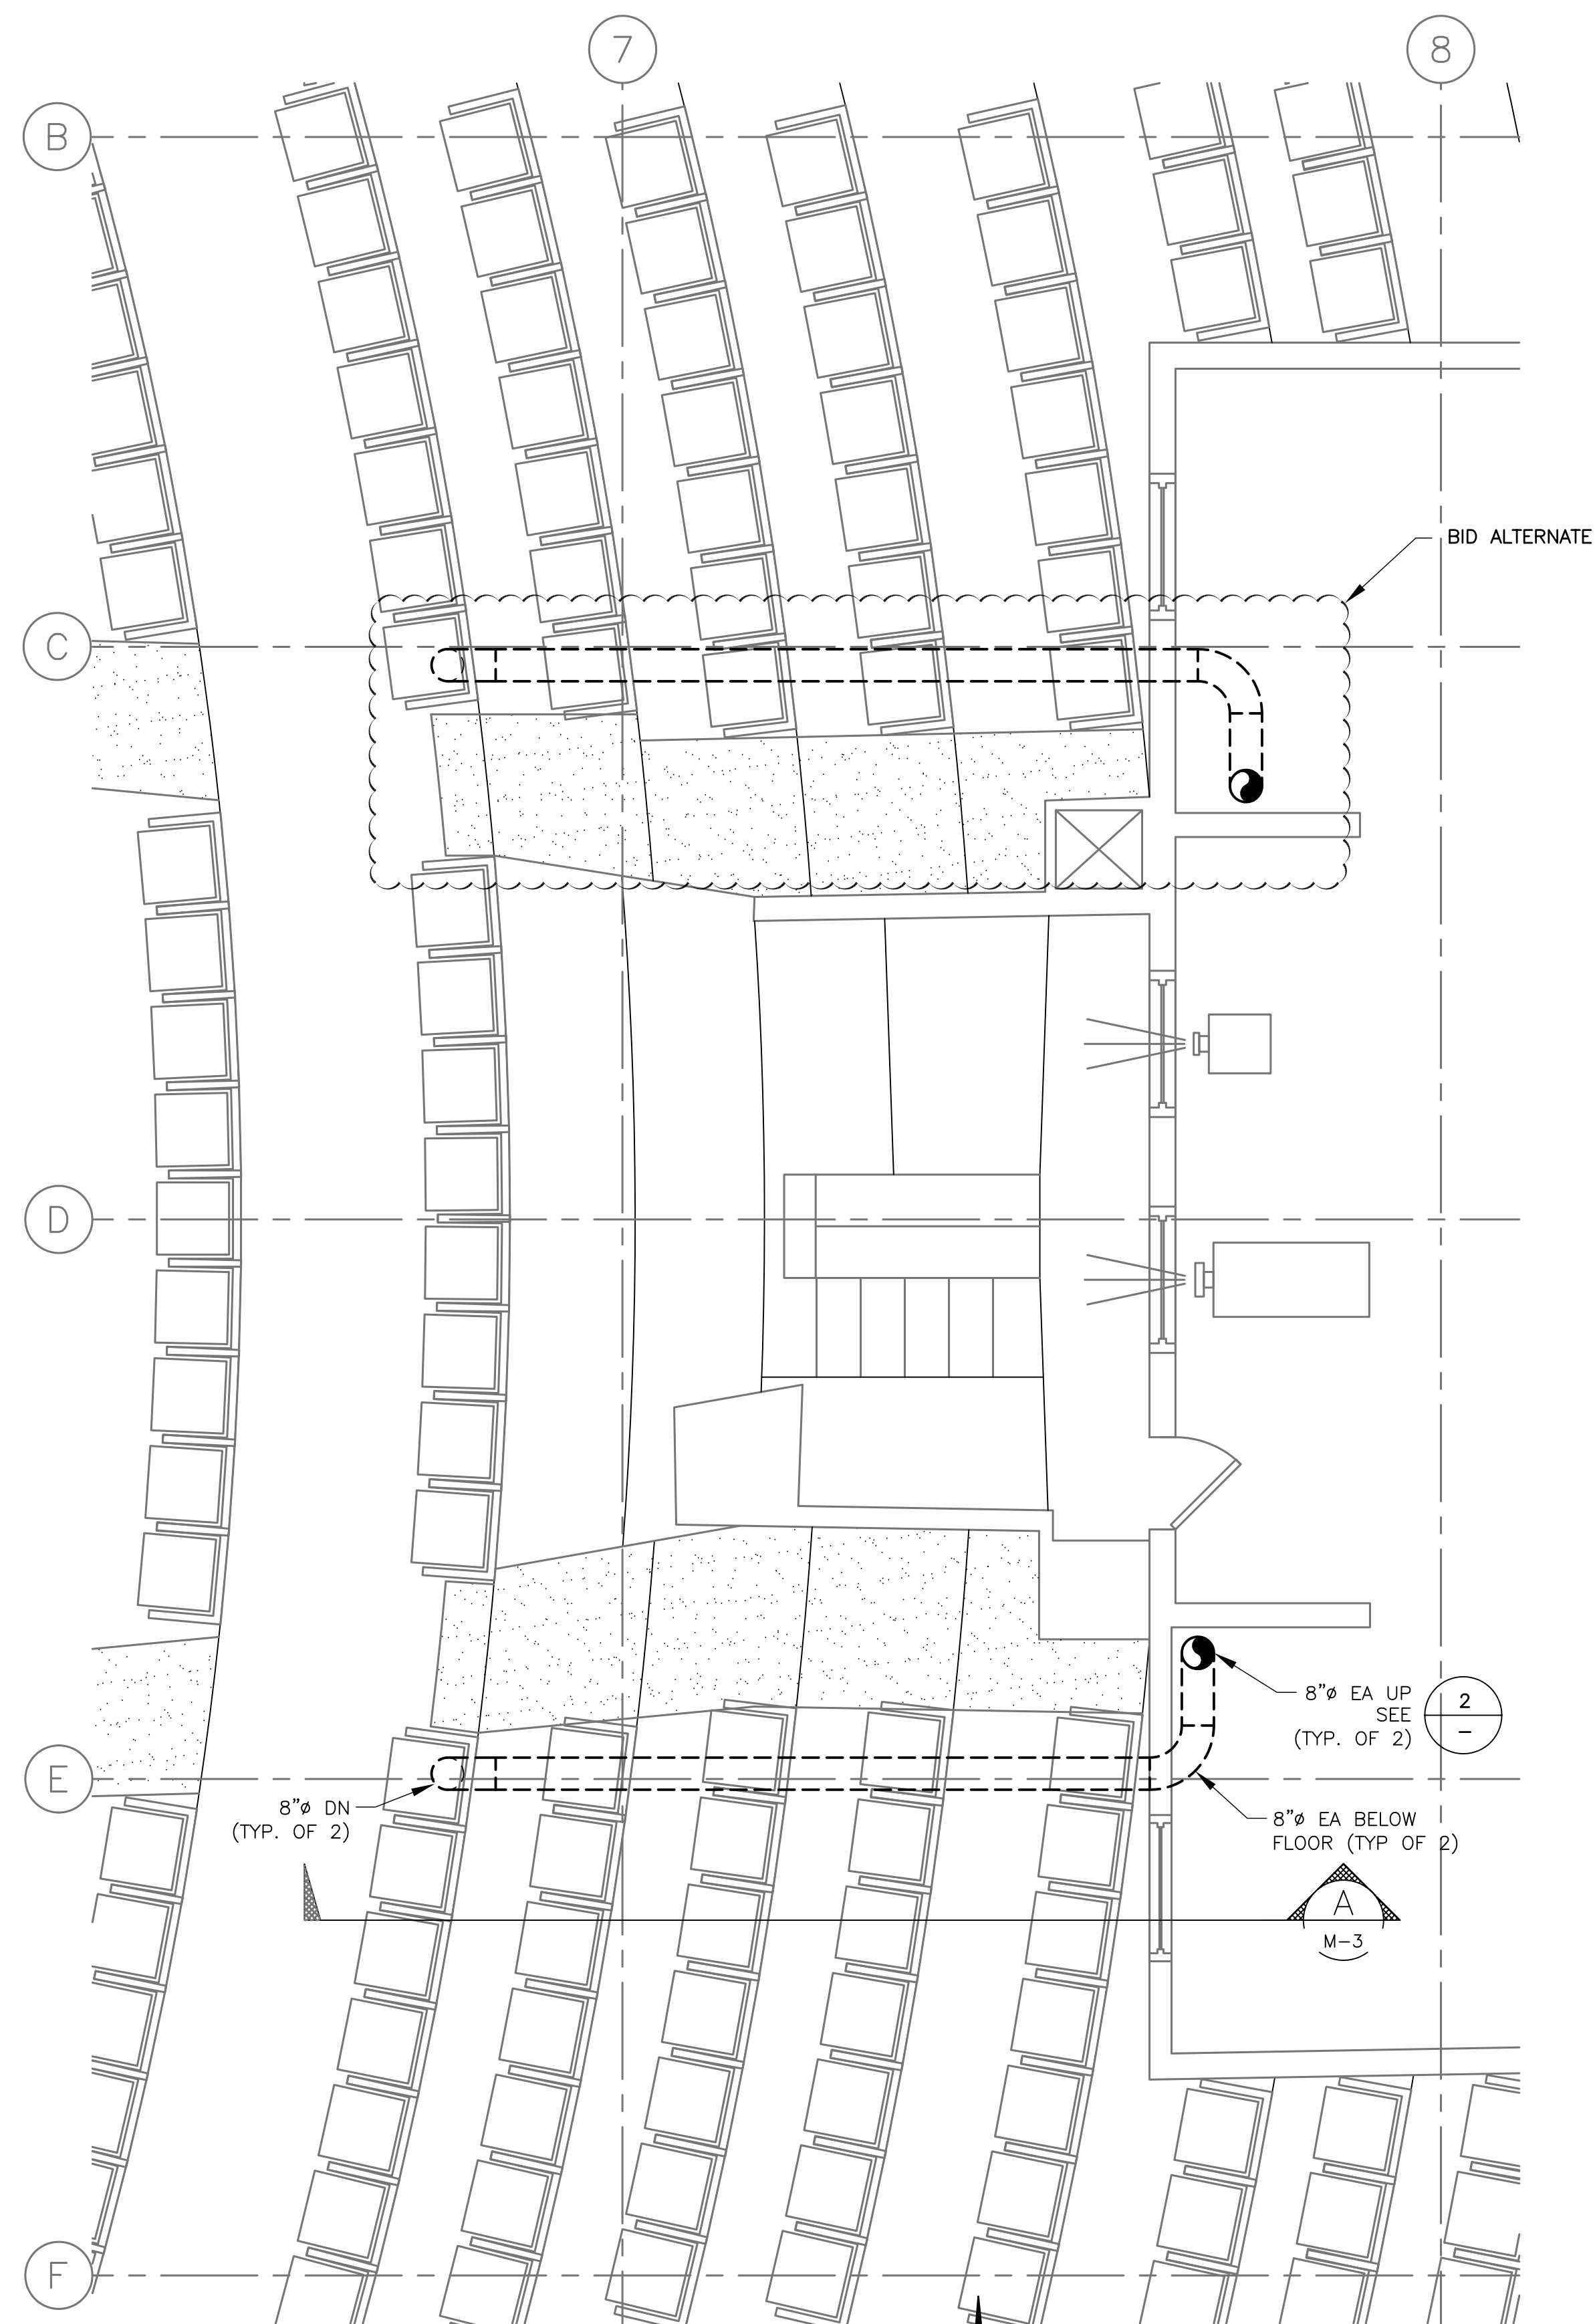


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HVAC PLANS
& SECTION - 1

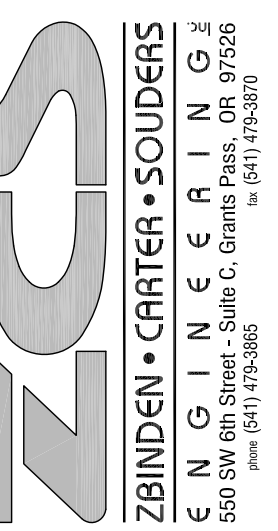M-3

NO.	REVISED	BID SET	REVISIONS	BY	DATE
1				EP	7/1/13



BAR EQUALS ONE
INCH WHEN DRAWING
IS PLOTTED FULL SIZE.
IF NOT, SCALE ACCORDINGLY

NOTES:

1. SEE LEGEND AND GENERAL NOTES ON SHEET M-1.

REGISTERED PROFESSIONAL
ENGINEER
10981
OREGON
FEB. 19, 1981
DANIEL J. WEHAGE
EXPIRES: 06/30/14



ArcSine engineering
A full-spectrum engineering company

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1258 Drive Drive | Medford, OR 97501 | (541)842-4188
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JJ 1325-M-2.dwg

CHECKED: D. WEHAGE

DATE: 7-2-2013

VAC PLANS
SECTION - 2

M-3.1

NO.	REVISIONS	BY	DATE

PIPING SYMBOLS

SOIL PIPE ABOVE FLOOR OR GRADE

BUILDING SANITARY BELOW FLOOR OR GRADE

VENT

COLD WATER

HOT WATER

HOT WATER RETURN

PIPE DOWN

PIPE UP

TEE DOWN

TEE UP

ELBOW

TEE

CAP

CONCENTRIC REDUCER / INCREASER

UNION

DIRECTION OF FLOW

PUMP

FLOOR CLEAN-OUT

CLEAN-OUT TO GRADE

WALL CLEAN-OUT

SHUT-OFF VALVE ON RISER TO DROP

WATER HAMMER ARRESTER

HOSE BIBB (WALL HYDRANT)

SHUT-OFF VALVE (BALL VALVE)

SHUT-OFF VALVE (GATE VALVE)

GLOBE VALVE

CHECK VALVE

RP BACK FLOW DEVICE

PRESSURE REDUCING VALVE

PRESSURE GAUGE

SAFETY RELIEF VALVE

THERMOMETER

TEMPCONTROL MIXING VALVE

EXISTING

RELOCATED

POINT OF NEW CONNECTION

REVISION NUMBER

EQUIPMENT TAG
EQUIPMENT NUMBER

SECTION (LETTER) OR DETAIL
(NUMERICAL) DESIGNATION SHEET NUMBER

SECTION (LETTER) OR DETAIL
(NUMERICAL) DESIGNATION SHEET NUMBER

GENERAL BREAK

LINE BREAK

PLUMBING FIXTURE UNITS (FU)
W/ PIPE SIZE (INCHES)

PLUMBING FIXTURE DESIGNATION

XX

X

XX-X

GENERAL SYMBOLS

EXISTING

RELOCATED

POINT OF NEW CONNECTION

REVISION NUMBER

EQUIPMENT TAG
EQUIPMENT NUMBER

SECTION (LETTER) OR DETAIL
(NUMERICAL) DESIGNATION SHEET NUMBER

SECTION (LETTER) OR DETAIL
(NUMERICAL) DESIGNATION SHEET NUMBER

GENERAL BREAK

LINE BREAK

PLUMBING FIXTURE UNITS (FU)
W/ PIPE SIZE (INCHES)

PLUMBING FIXTURE DESIGNATION

XX

X

XX-X

NOTE: ABBREVIATIONS AND SYMBOLS ARE
ARCSINE ENGINEERING STANDARDIZED SYMBOL
LEGENDS. AS SUCH, ALL SYMBOLS SHOWN
MAY NOT APPEAR ON OR WITHIN THIS SET
OF CONTRACT DOCUMENTS.

GENERAL NOTES

1. PROVIDE ALL LABOR, MATERIALS, AND EQUIPMENT NECESSARY TO CONSTRUCT A COMPLETE, OPERATIONAL PLUMBING SYSTEM FOR THE ENTIRE PROJECT AS SHOWN ON THESE DRAWINGS, INCLUDING ALL NECESSARY FEES AND PERMITS.

2. THE ENTIRE INSTALLATION SHALL CONFORM TO THE REQUIREMENTS OF THE MOST RECENTLY ADOPTED PLUMBING CODE, MECHANICAL CODE, BUILDING CODE AND ALL OTHER APPLICABLE CITY, COUNTY, AND STATE CODES AND REGULATIONS IN EFFECT AT THE DATE OF THE BID. CONFORM TO ANY CODES, RULES, REGULATIONS AND REQUIREMENTS THAT THE PROJECT OWNER HAS.

3. OBTAIN ALL INSPECTION APPROVALS ON PLUMBING WORK FROM REGULATING AGENCIES WHERE REQUIRED.

4. PRIOR TO FABRICATION AND INSTALLATION THE CONTRACTOR SHALL COORDINATE THE INSTALLATION OF ALL PLUMBING PIPING AND EQUIPMENT WITH MECHANICAL PIPING, EQUIPMENT, DUCTWORK, AND ALL OTHER TRADES INCLUDING BUT NOT LIMITED TO THE MECHANICAL CONTRACTOR, ELECTRICAL CONTRACTOR AND GENERAL CONTRACTOR. WHERE CONFLICTS MAY OCCUR, THEY SHALL BE RESOLVED PRIOR TO INSTALLATION.

5. THE DRAWINGS SHOW THE GENERAL DESIGN, ARRANGEMENTS AND THE EXTENT OF THE SYSTEM. IT SHALL BE THE WORK OF THE CONTRACTOR TO MAKE SUCH SLIGHT ALTERATIONS AS MAY BE NECESSARY TO MAKE THE SYSTEM COMPLETE AND OPERATIONAL IN ACCORDANCE WITH THE DESIGN INTENT. MAJOR DEVIATIONS SUCH AS CHANGES IN COMPONENT SIZES, WEIGHTS, QUANTITIES, OR MATERIAL REQUIRE PRIOR APPROVAL BY THE CONSULTING ENGINEER.

6. CONTRACTORS AND SUB-CONTRACTORS SHALL CAREFULLY REVIEW THE CONSTRUCTION DOCUMENTS. INFORMATION REGARDING THE COMPLETE WORK IS DISPERSED THROUGHOUT THE DOCUMENT SET AND CANNOT BE ACCURATELY DETERMINED WITHOUT REFERENCE TO THE COMPLETE DOCUMENT SET.

7. SEE ARCHITECTURAL DRAWINGS FOR EXACT LOCATION OF ALL PLUMBING FIXTURES.

8. THE WORKING DRAWINGS ARE DIAGRAMMATIC. BECAUSE OF THE SMALL SCALE OF THE DRAWINGS, THEY DO NOT SHOW EVERY OFFSET, BEND OR ELBOW NECESSARY FOR THE COMPLETE INSTALLATION IN THE SPACE PROVIDED. ALL LOCATIONS FOR PLUMBING EQUIPMENT AND PIPING SHALL BE CHECKED AND COORDINATED WITH THE ARCHITECTURAL, MECHANICAL, STRUCTURAL AND ELECTRICAL DRAWINGS.

9. EXACT ROUTING OF WASTE, GAS, AND WATER SERVICE IS DEPENDENT ON LOCAL SITE CONDITIONS AND MODIFICATIONS IN EQUIPMENT CONNECTIONS. EXACT LOCATION OF EQUIPMENT MAY VARY DEPENDING ON LOCAL CODE, HEALTH DEPARTMENT AND CITY REQUIREMENTS.

10. DETAILS: THE CONTRACTOR IS RESPONSIBLE TO REVIEW AND USE WHERE APPROPRIATE ALL OF THE PLUMBING DETAILS SHOWN ON THE DRAWINGS. DETAILS MAY OR MAY NOT BE CALLED OUT ON THE DRAWINGS WITH SYMBOLS OR KEYED NOTES. ANY CHANGES RESULTING FROM FAILURE TO INSTALL THE PLUMBING SYSTEM WITHOUT USING THE INCLUDED DETAILS IS THE RESPONSIBILITY OF THE CONTRACTOR.

11. THE DRAWINGS HAVE BEEN PREPARED TO SUPPLEMENT EACH OTHER AND

THEY SHALL BE INTERPRETED AS AN INTEGRAL UNIT WITH THE ITEMS SHOWN ON ONE AND NOT THE OTHER BEING FURNISHED AND INSTALLED AS THOUGH SHOWN AND CALLED OUT IN BOTH.

12. PREPARE 6 COPIES OF SUBMITTALS IN AN INDEXED, LABELED FOLDER CONTAINING FULL PERFORMANCE, MATERIAL AND INSTALLATION INFORMATION ABOUT ALL EQUIPMENT, PIPING, COMPONENTS AND ACCESSORIES TO BE USED. ARCSINE ENGINEERS WILL CHECK SUBMITTALS AT MOST TWICE. TIME SPENT ON SUBSEQUENT SUBMITTALS WILL BE BILLED TO THE CONTRACTOR BY THE ENGINEER AT ITS CURRENT HOURLY RATES.

13. THE STRUCTURE SHOWN ON ALL DETAILS MAY OR MAY NOT PERTAIN TO A PORTION OR ANY PORTION OF THE BUILDING. COORDINATE MOUNTING REQUIREMENTS WITH ARCHITECTURAL AND STRUCTURAL DRAWINGS.

14. ANY PART OF THIS INSTALLATION THAT FAILS, IS UNFIT, OR BECOMES DAMAGED DURING CONSTRUCTION SHALL BE REPAIRED OR REPLACED BY THE CONTRACTOR AT NO ADDITIONAL COST TO THE OWNER.

15. IF CONTRACTOR ENCOUNTERS MATERIAL WHICH MAY CONTAIN ASBESTOS, IMMEDIATELY STOP WORK IN THIS AREA AND NOTIFY THE OWNER.

16. ALL EQUIPMENT SHALL BE INSTALLED IN STRICT ACCORDANCE WITH THE EQUIPMENT MANUFACTURER'S RECOMMENDATIONS. PROVIDE ALL FITTINGS, TRANSITIONS, VALVES, AND OTHER DEVICES AND ACCESSORIES REQUIRED FOR A COMPLETE, WORKABLE INSTALLATION.

17. EXISTING INTERIOR PIPING AND EQUIPMENT HAS BEEN LOCATED IN AN APPROXIMATE WAY ONLY. THE CONTRACTOR SHALL VERIFY LOCATIONS, POINTS OF CONNECTION, PIPE SIZES AND PIPE ROUTING THROUGH EXISTING CONDITIONS PRIOR TO COMMENCING WORK.

18. THE CONTRACTOR SHALL PERFORM THE WORK IN A MANNER THAT WILL CAUSE A MINIMUM DISRUPTION TO BUILDING TENANT USE AND SHALL COORDINATE THE WORK WITH THE BUILDING OWNER'S REPRESENTATIVE.

19. THE CONTRACTOR IS RESPONSIBLE FOR PLUMBING EQUIPMENT CHECK-IN, SAFEKEEPING, AND DAMAGE.

20. ALL OPENINGS FOR PIPING THROUGH FIRE-RATED ENCLOSURES SHALL BE CAULKED AS REQUIRED BY CODE TO MAINTAIN FIRE RATING.

21. PIPE INSULATION (ABOVE GRADE):

22. HOT WATER: PROVIDE A MINIMUM OF 1" THICK INSULATION (CONDUCTIVITY NOT EXCEEDING 0.27 BTU/IN/HR--FT--F) ON ALL SERVICE HOT WATER AND HOT WATER RECIRCULATION PIPING.

23. COLD WATER: PROVIDE 1/2" THICK INSULATION ON PIPE INSTALLED ABOVE GRADE WITHIN THE BUILDING FOR CONDENSATION CONTROL.

24. LAVATORY AND SINK FAUCETS SHALL HAVE A FLOW RATE OF 0.5 GPM.

25. ANY SHUT DOWNS REQUIRED TO CONNECT TO ALL ACTIVE PIPING ARE TO BE COORDINATED WITH OWNER.

26. ALL VALVES CONCEALED IN CEILING OR WALLS SHALL BE PROVIDED WITH

ACCESS PANELS. LOCATE ON "AS BUILT" DRAWINGS.

27. ALL UNDERGROUND SOIL AND WASTE PIPING TO A POINT 5'-0" OUT FROM BUILDING SHALL BE RUN AT A MINIMUM SLOPE OF 1/4" PER FT.

28. BELOW GRADE CW PIPING SHALL BE TYPE K COPPER OR PEX TUBING (TYPE "A"). ABOVE GRADE PIPING SHALL BE TYPE L COPPER OR PEX TUBING (TYPE "A"). SANITARY DRAIN AND VENT PIPING SHALL BE ABS--DWV FOR BELOW AND ABOVE GRADE PIPING.

29. LOCATE ALL PLUMBING VENTS AT LEAST 3 FEET ABOVE OR 10 FEET AWAY FROM ALL OUTSIDE AIR INTAKES INTO THE BUILDING.

30. SEE "PLUMBING FIXTURE SCHEDULE" FOR FIXTURE MAKE AND TYPE, AND SIZE OF INDIVIDUAL WASTE, VENT, AND DOMESTIC WATER PIPING TO FIXTURES.

31. ALL PLUMBING EQUIPMENT SHALL BE LISTED AND LABELED BY AN APPROVED TESTING AGENCY.

32. EQUIPMENT AND INSTALLATION SHALL MEET NATIONAL SANITATION FOUNDATION (NSF) STANDARDS, OR EQUIVALENT.

33. PROVIDE PROPER PROVISIONS FOR EXPANSION OR MOVEMENT OF ALL PIPING.

34. ALL PIPING SHALL BE SECURED BY DOUBLE NUTTING AT THE HANGER ROD ATTACHMENT TO THE STRUCTURE AND AT THE PIPE HANGER.

35. TWO OPERATING AND MAINTENANCE MANUALS SHALL BE PROVIDED IN HARD BACK LOOSE LEAF BINDERS. MANUALS SHALL CONTAIN PRODUCT CUT SHEETS AND OPERATING AND MAINTENANCE INSTRUCTIONS ON ALL EQUIPMENT, ACCESSORIES, FIXTURES, VALVES, ETC., PROVIDED FOR THE PROJECT.

36. UPON COMPLETION OF THE WORK, REMOVE ALL SURPLUS MATERIALS AND RUBBISH. MAKE ALL REQUIRED PATCHING AND REPAIRS OF OTHER TRADES' WORK DAMAGED BY THIS CONTRACTOR, AND LEAVE THE PREMISES IN A CLEAN, ORDERLY CONDITION.

37. THE CONTRACTOR SHALL OPERATE THE SYSTEM AND DEMONSTRATE ALL ASPECTS TO THE ENGINEER AND/OR OWNER, TO PROVE ITS OPERATION.

38. THE CONTRACTOR SHALL GUARANTEE THE PLUMBING SYSTEM FOR A PERIOD OF ONE YEAR FROM THE DATE OF SUBSTANTIAL COMPLETION.

39. THE CONTRACTOR SHALL, DURING CONSTRUCTION, MAINTAIN A SET OF AS-BUILT REDLINED RECORD DRAWINGS AT THE PROJECT SITE. ALL CHANGES IN LAYOUT, ROUTING, EQUIPMENT, COMPONENTS, AND ACCESSORIES SHALL BE RECORDED. THE CONTRACTOR IS RESPONSIBLE FOR CONVERTING THE CONSTRUCTION REDLINE DRAWINGS INTO "AS BUILT" DRAWINGS USING AUTOCAD BACKGROUNDS PROVIDED BY THE ENGINEER. IF THE CONTRACTOR DOES NOT HAVE AUTOCAD DRAFTING CAPABILITIES, THE CONTRACTOR SHALL HIRE THE ENGINEER TO PRODUCE THE "AS BUILT" DRAWINGS FROM HIS FIELD REDLINES. COMPLETED AUTOCAD "AS BUILT" SHALL BE GIVEN TO THE ARCHITECT/ENGINEER AFTER THE FINAL INSPECTION.

PLUMBING ABBREVIATIONS															
AD	ACCESS DOOR	DN	DOWN	HW	HOT WATER (POTABLE)										
AFF	ABOVE FINISH FLOOR	DW	DISHWASHER	HWR	HOT WATER RETURN										
ARCH	ARCHITECT OR ARCHITECTURAL	DWG	DRAWING												
BLDG	BUILDING	ELEV	ELEVATION	INT	INITIAL WORK TO BE DONE										
BFF	BELOW FINISH FLOOR	ET	EXPANSION TANK	L	LAVATORY										
BM	BEAM	EW	ENTERING WATER TEMPERATURE	LB(S)	POUND, POUNDS										
BOP	BOTTOM OF PIPE	EW	EYE WASH FOUNTAIN												
BOS	BOTTOM OF STEEL	EW	ELECTRIC WATER HEATER	MBH	THOUSAND BTU PER HOUR										
BTU	BRITISH THERMAL UNIT	EW		MC	MECHANICAL CONTRACTOR										
				MCA	MINIMUM CIRCUIT CAPACITY										
CA	COMPRESSED AIR	FC	FLEXIBLE CONNECTION	MECH	MECHANICAL										
CLG	CEILING	FLR	FLOOR	MFR	MANUFACTURER										
CO	CLEAN OUT	FU	FIXTURE UNITS	MIN	MINIMUM										
CTG	CLEAN OUT TO GRADE	FUT	FUTURE WORK TO BE DONE	MOCP	MAXIMUM OVERCURRENT PROTECTION										
CONSTR	CONSTRUCTION														
CW	COLD WATER (POTABLE)	GC	GENERAL CONTRACTOR												
		GPM	GALLONS PER MINUTE	NC	NORMALLY CLOSED										
DCW	DOMESTIC CLOTHES WASHER	NG	NATURAL GAS	NTS	NOT TO SCALE										
DF	DRINKING FOUNTAIN	HB	HOSE BIBB												
DIA	DIAMETER	HP	MOTOR HORSEPOWER												
		HR	HOUR												

PLUMBING FIXTURE SCHEDULE						
TAG	DESCRIPTION	MINIMUM CONNECTION SIZE				REMARKS
		WASTE	VENT	CW	HW	
L-1	LAVATORY (WALL HUNG)	2"	2"	1/2"	1/2"	AMERICAN STANDARD ROXALYN LAVATORY MODEL 0195.073, W/ CONCEALED ARMS LAVATORY SUPPORT, J.R. SMITH 0700(-E). CHICAGO FAUCETS 857-E2805-665PSHCP METERING FAUCET. PROVIDE INSULATED PIPE COVERINGS.
L-2	LAVATORY (WALL HUNG)	2"	2"	1/2"	1/2"	AMERICAN STANDARD ROXALYN LAVATORY MODEL 0195.073, W/ CONCEALED ARMS LAVATORY SUPPORT, J.R. SMITH 0700(-E). CHICAGO FAUCETS 857-E2805-665PSHCP METERING FAUCET. PROVIDE INSULATED PIPE COVERINGS.
WC-1	WATER CLOSET (FLOOR MOUNT)	3"	2"	1/2	-	AMERICAN STANDARD CADET 2377.100 FLOOR MOUNTED ELONGATED BOWL W/ PRESSURE ASSIST TYPE TANK TOILET. OPEN SEAT, WHITE. LEFT HAND TRIP LEVER
WC-2	WATER CLOSET (FLOOR MOUNT)	3"	2"	1/2"	-	AMERICAN STANDARD CADET 2377.100 FLOOR MOUNTED ELONGATED BOWL W/ PRESSURE ASSIST TYPE TANK TOILET. OPEN SEAT, WHITE. RIGHT HAND TRIP LEVER
WH-1	WATER HEATER	-	-	1/4"	1/4"	CHRONOMITE POINT OF USE WATER HEATER MODEL SR-30L, 3600W, 110/120V, 30A BREAKER SIZE, WT. 5 LB., 1/4" FEMALE NPT PIPE CONNECTIONS, 49°F WATER TEMPERATURE RISE AT 0.5 GPM FLOW RATE. MOUNT BELOW L-1.
WH-2	WATER HEATER	-	-	1/4"	1/4"	CHRONOMITE POINT OF USE WATER HEATER MODEL SR-30L, 3600W, 110/120V, 30A BREAKER SIZE, WT. 5 LB., 1/4" FEMALE NPT PIPE CONNECTIONS, 49°F WATER TEMPERATURE RISE AT 0.5 GPM FLOW RATE. MOUNT BELOW L-2.

P-1

LEGEND, NOTES, ABBREVIATIONS & FIXTURE SCHEDULE

P-2

UNDER FLOOR/FIRST FLOOR PLUMBING PLAN AND DETAILS

P-3

PLUMBING DETAILS

REGISTERED PROFESSIONAL ENGINEER
10081
DANIEL J. WEHAGE
OREGON
7th, 19, 2007

EXPIRES: 06/30/12

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CITY OF COOS BAY

EGYPTIAN THEATRE RESTROOMS

PROJECT NO: 1325


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LEGEND, NOTES, ABBREVIATIONS & FIXTURE SCHEDULE

P-1




GENERAL NOTES

A. CONTRACTOR SHALL INSPECT EXISTING SANITARY BUILDING DRAIN AND REPORT ON ITS CONDITION TO THE CITY OF COOS BAY FOR POSSIBLE REPLACEMENT IF EXISTING CONDITION WARRANTS REPLACEMENT.

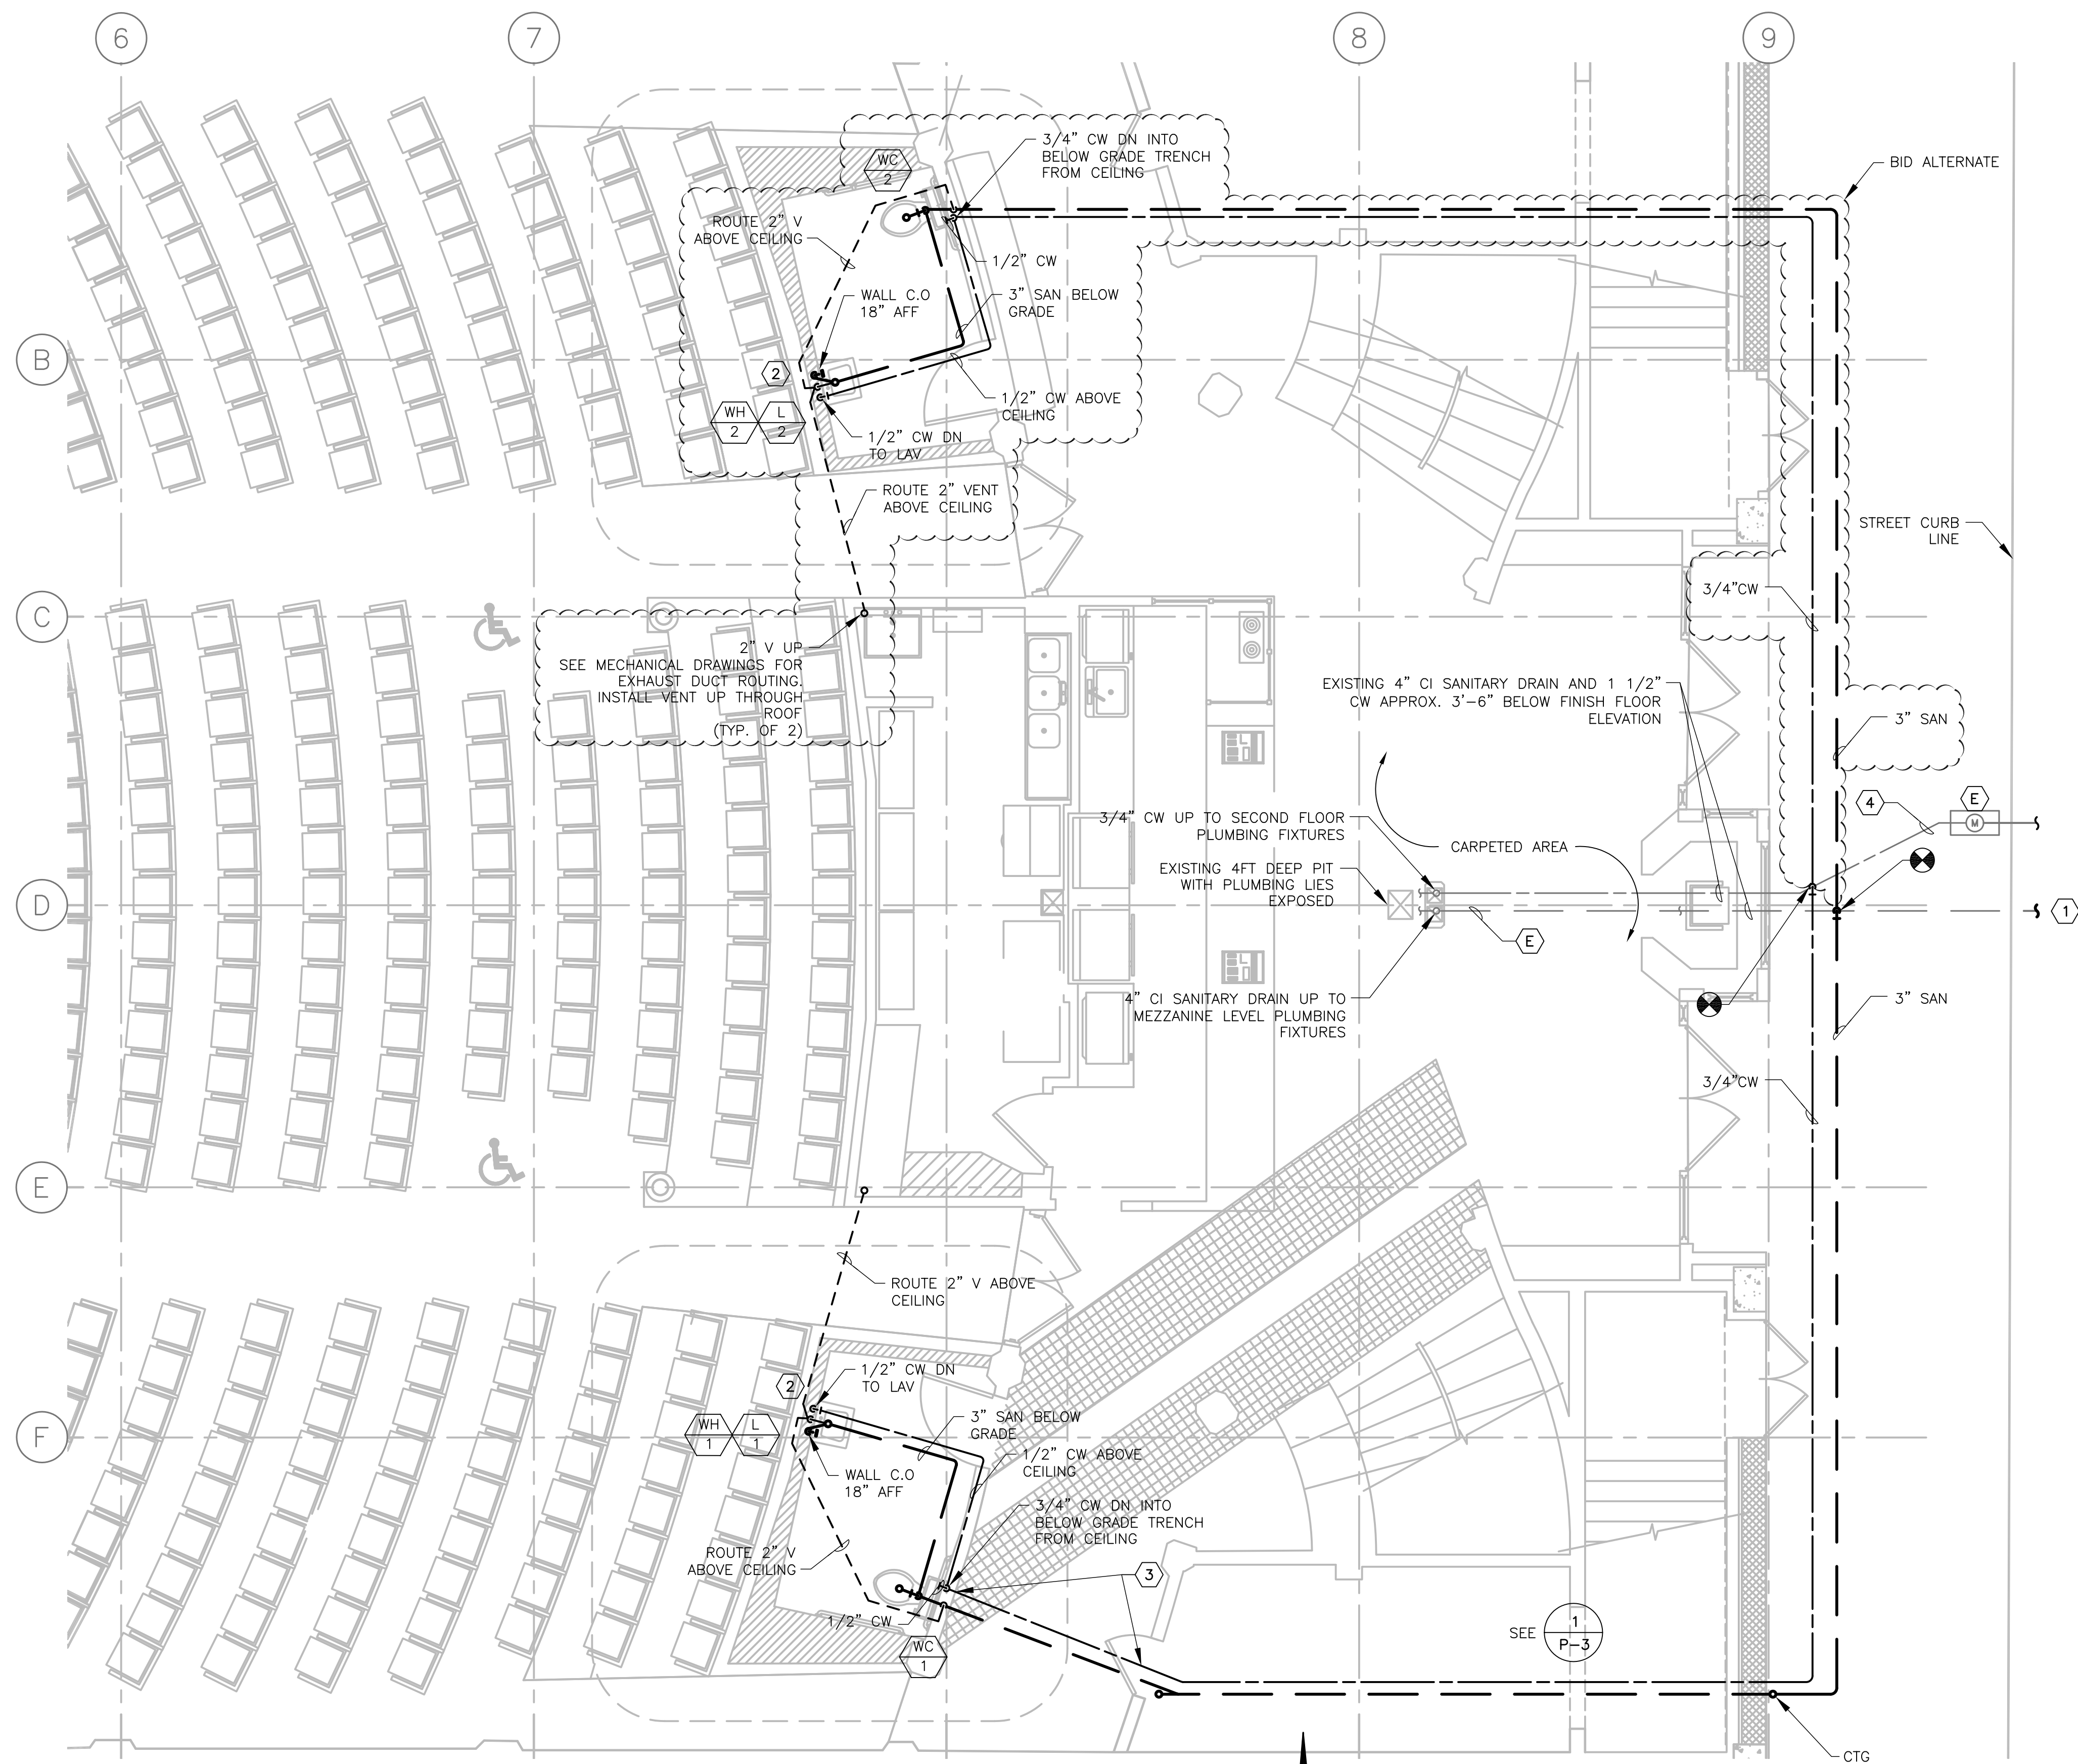KEYED NOTES

- 1 EXISTING 4" BUILDING DRAIN CONTINUES TO SEWER LINE.
- 2 LOCATE POINT OF USE WATER HEATERS WH-1 AND WH-2 ON WALL BELOW LAVATORY.
- 3 INSTALL 3/4" WATER LINE AND 3" SANITARY BUILDING DRAIN BELOW TILE FLOOR BY BORING BENEATH CONCRETE SLAB AND TILE FLOOR. WATER LINE SHALL BE A MINIMUM OF 12" ABOVE SAN BUILDING DRAIN AND OFFSET TO ONE SIDE AS SHOWN IN DETAIL 1/P-3.
- 4 EXISTING 1 1/2" CW.

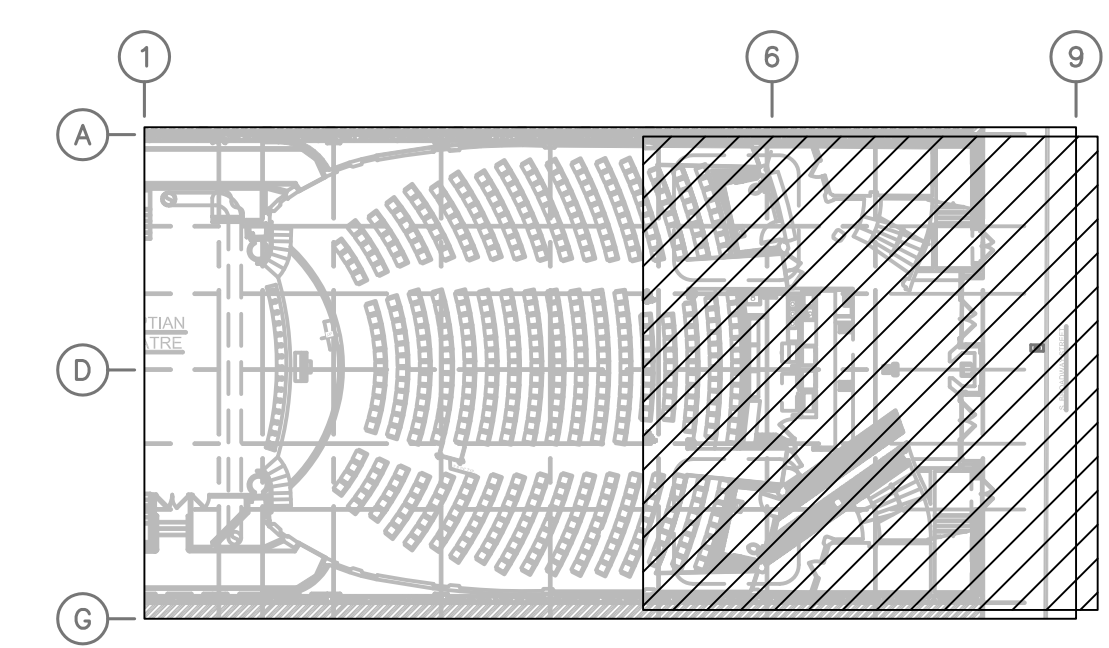

WORK AREA

1 PLUMBING PLAN
SCALE: 3/8"=1'-0"

NOTES:
1. SEE LEGEND AND GENERAL NOTES ON SHEET P-1.

1 INCH
BAR EQUALS ONE
INCH WHEN DRAWING
IS PLOTTED FULL SIZE.
IF NOT, SCALE ACCORDINGLY



CITY OF COOS BAY		EGYPTIAN THEATRE RESTROOMS	
PROJECT NO: 1325		DRAWN: JJ 1325-P-2.dwg	
CHECKED: D. WEHAGE		DATE: 7-2-2013	
PLUMBING PLAN		P-2	

REVISIONS

NO.	REVISED BID SET	BY	DATE
1		EP	7/1/13

